

BASEMENT FLOOR LAYOUT SCALE 1:100

SUMMARY OF RENOVATION WORKS AT BASEMENT FLOOR LEVEL

- -Lab waste management plant system to be removed and carefully disposed of. The room to be converted into a store.
- Inspection and proposing a solution for the leakages in plumbing and drainage pipeworks.
- -Proposing a solution for the poor drainage as highlighted.
- -Introducing /creating/repairing emergency exit doors and clearly labelling them.
- Inspect for any existing cracks and repair as per the procedure in the specifications.
- -Covert the existing generator room to a store, introduce doors as indicated.
- Inspect drainage pipeworks along the ceiling and wall for any leakages and repair accordingly, making good any affected walling plaster work or paint work as a result of leakages repair.

works as per the attached User requirement specification document **LEGEND**



Areas to be worked on labelled in red

Areas where no action is to be taken labelled in black

C-BSC - CLEAN BIOSAFETY CABINET D-BSC - DIRTY BIOSAFETY CABINET B6 - BSC 6ft. B4 - BSC 4ft. HWS - HANDWASH SINK

S - SI - FRIDGE Fr. - FREEZER

- INCUBATOR C - CENTRIFUGE

960 - MGT960 P - PASS THROUGH INCLUDING SPECIMEN PLACEMENT BASE TO REQUIREMENTS

E - EQUIPMENT DOOR W - VIEWING SEALED WINDOW

SH - SHOWER EEW-EMERGENCY EYE WASH

ESH-EMERGENCY SHOWER DR - DRAWERS A - AUTOCLAVE

PL - PRINTER LABEL HB - HIGH BENCH _1050mm high LB - LOW BENCH_ 900mm high E.O.T.ELBOW OPERATED TAPS

F A- FREE STANDING AUTOCLAVE

ARCHITECTURAL NOTES.

- 1. All works to be carried out in accordance with Local
- Authority regulations.
 2. All figured dimensions to be taken in preference to scaled dimensions.
- 3. All walls below 200mm to be reinforced with hoop
- iron at every alternative course.
- 4. Provide damp proof course (D.P.C.) under all walls.
- 5. P.V. indicates permanent ventilations. All drainage passing under building and drive area to be of pvc pipe and encased in 150mm
- thick concrete surround.
- 7. All inspection chambers in drive area to have heavy duty covers.
- 8. Check all dimensions on site. 9. All sanitary work to be in accordance with MOH rules
- and regulations and NCC requirements. 10. 500g polythene sheeting and anti-termite treatment
- to be provided under ground floor concrete slab.
- 11. All reinforced concrete works to Structural Eng. detail.
- 12. Automatic booster pump for FHRs to be provided to
- the satisfaction of the Chief Fire Officer. 13. 4500 litres reserve for hose reel
- 14. Electrical fire alarm system to the approval of Chief Fire Officer.
- 15. Fire alarm and booster to be provided with
- secondary power supply.

 16. 2x9 kg Dry Powder Fire Extinguishers at areas shown.

Revision

17. 2x9 litre water and 1x4.5 kg CO2 fire extinguishers

Date

to be provided per floor.



Architects signature...

NATIONAL PUBLIC HEALTH LABORATORY, DEPARTMENT OF LABORATORY SERVICES (DLS), MINISTRY OF HEALTH P.O. BOX 20750-00202,

AMREF HEALTH AFRICA IN KENYA

WILSON AIRPORT,

Client sign

Project Title PROPOSED RENOVATION AND MAINTENANCE OF BSL III LABORATORIES AT NATIONAL PUBLIC HEALTH LABORATORY (BLOCK B) AT THE DEPARTMENT OF

KENYATTA NATIONAL HOSPITAL GROUNDS -OFF NGONG ROAD

Project No.TD/NKU/22/04/125

Drawing Title

BASEMENT FLOOR

BASEMENT FLOOR PLINTH AREA:

Drawing Status

WORKING DRAWINGS

JAN,2025

Scales


Drawn by Renovations/Design by Checked by

Arch. Boaz. Kim

1:100

Drawing Number

Status Revision

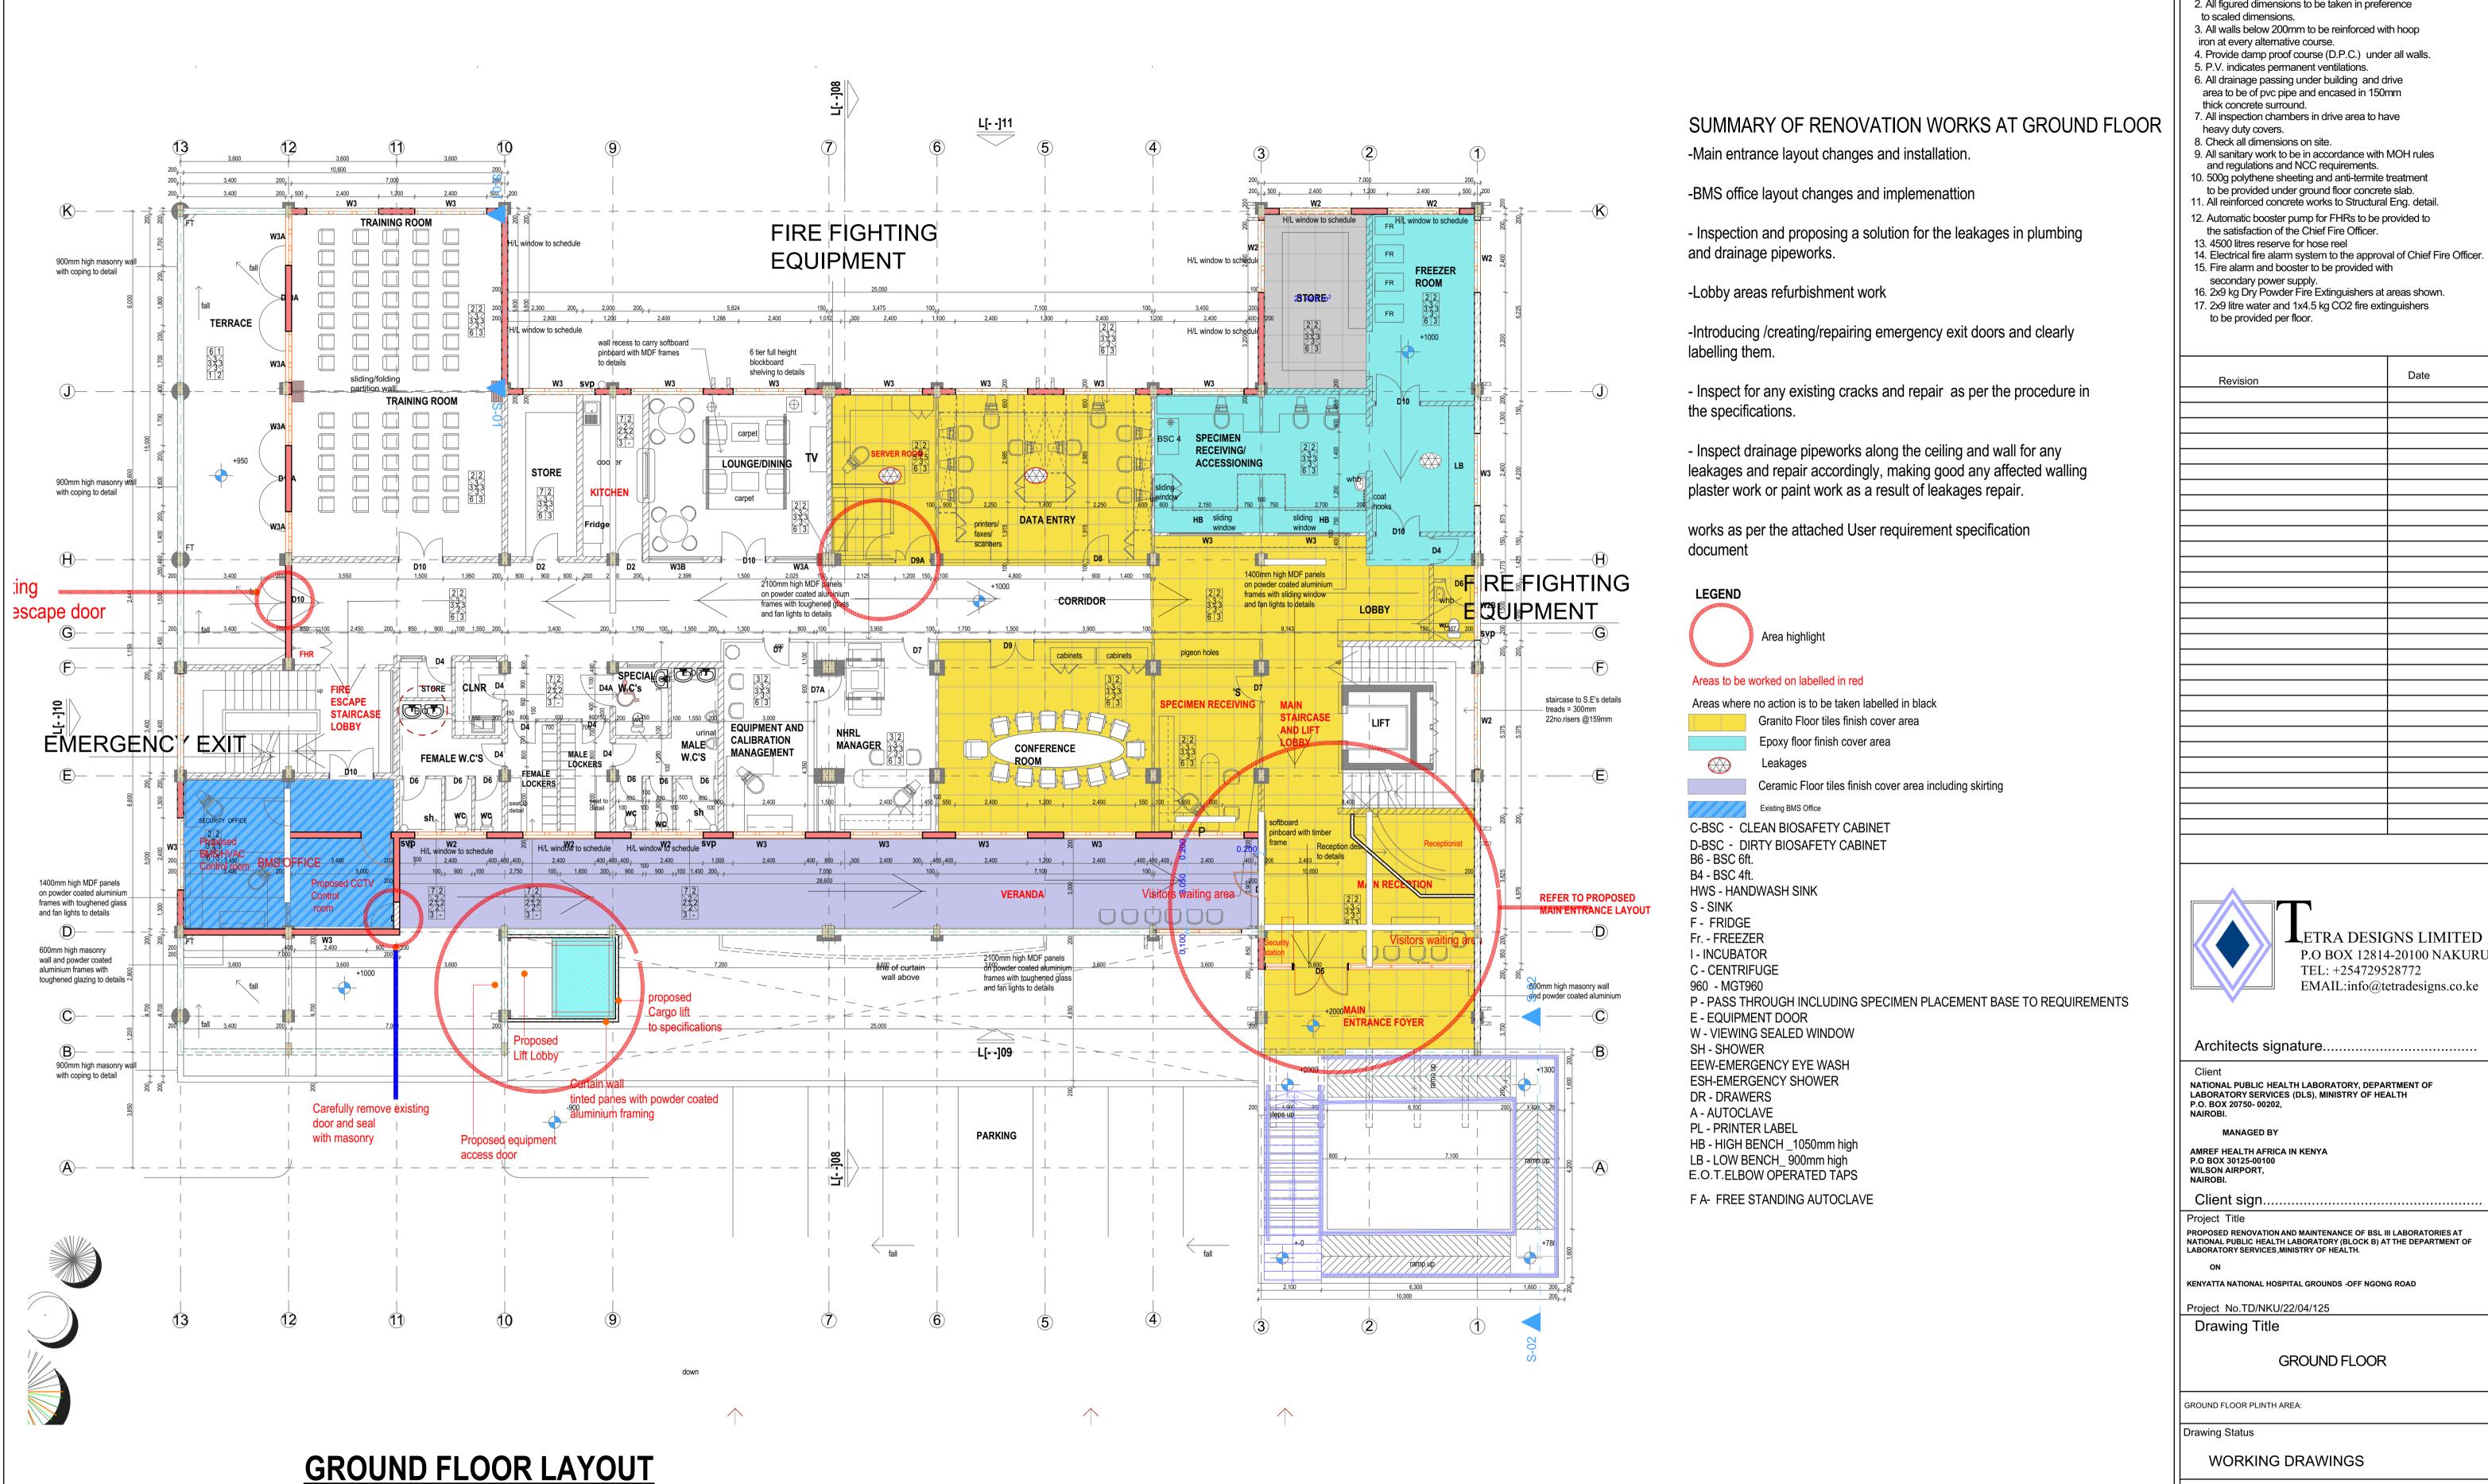

SCALE 1:100

ARCHITECTURAL NOTES.

1. All works to be carried out in accordance with Local Authority regulations.
2. All figured dimensions to be taken in preference


Drawn by Renovations/Design by Checked by Arch. Boaz. Kim JAN,2025

Scales

Drawing Number

1:100

Status Revision

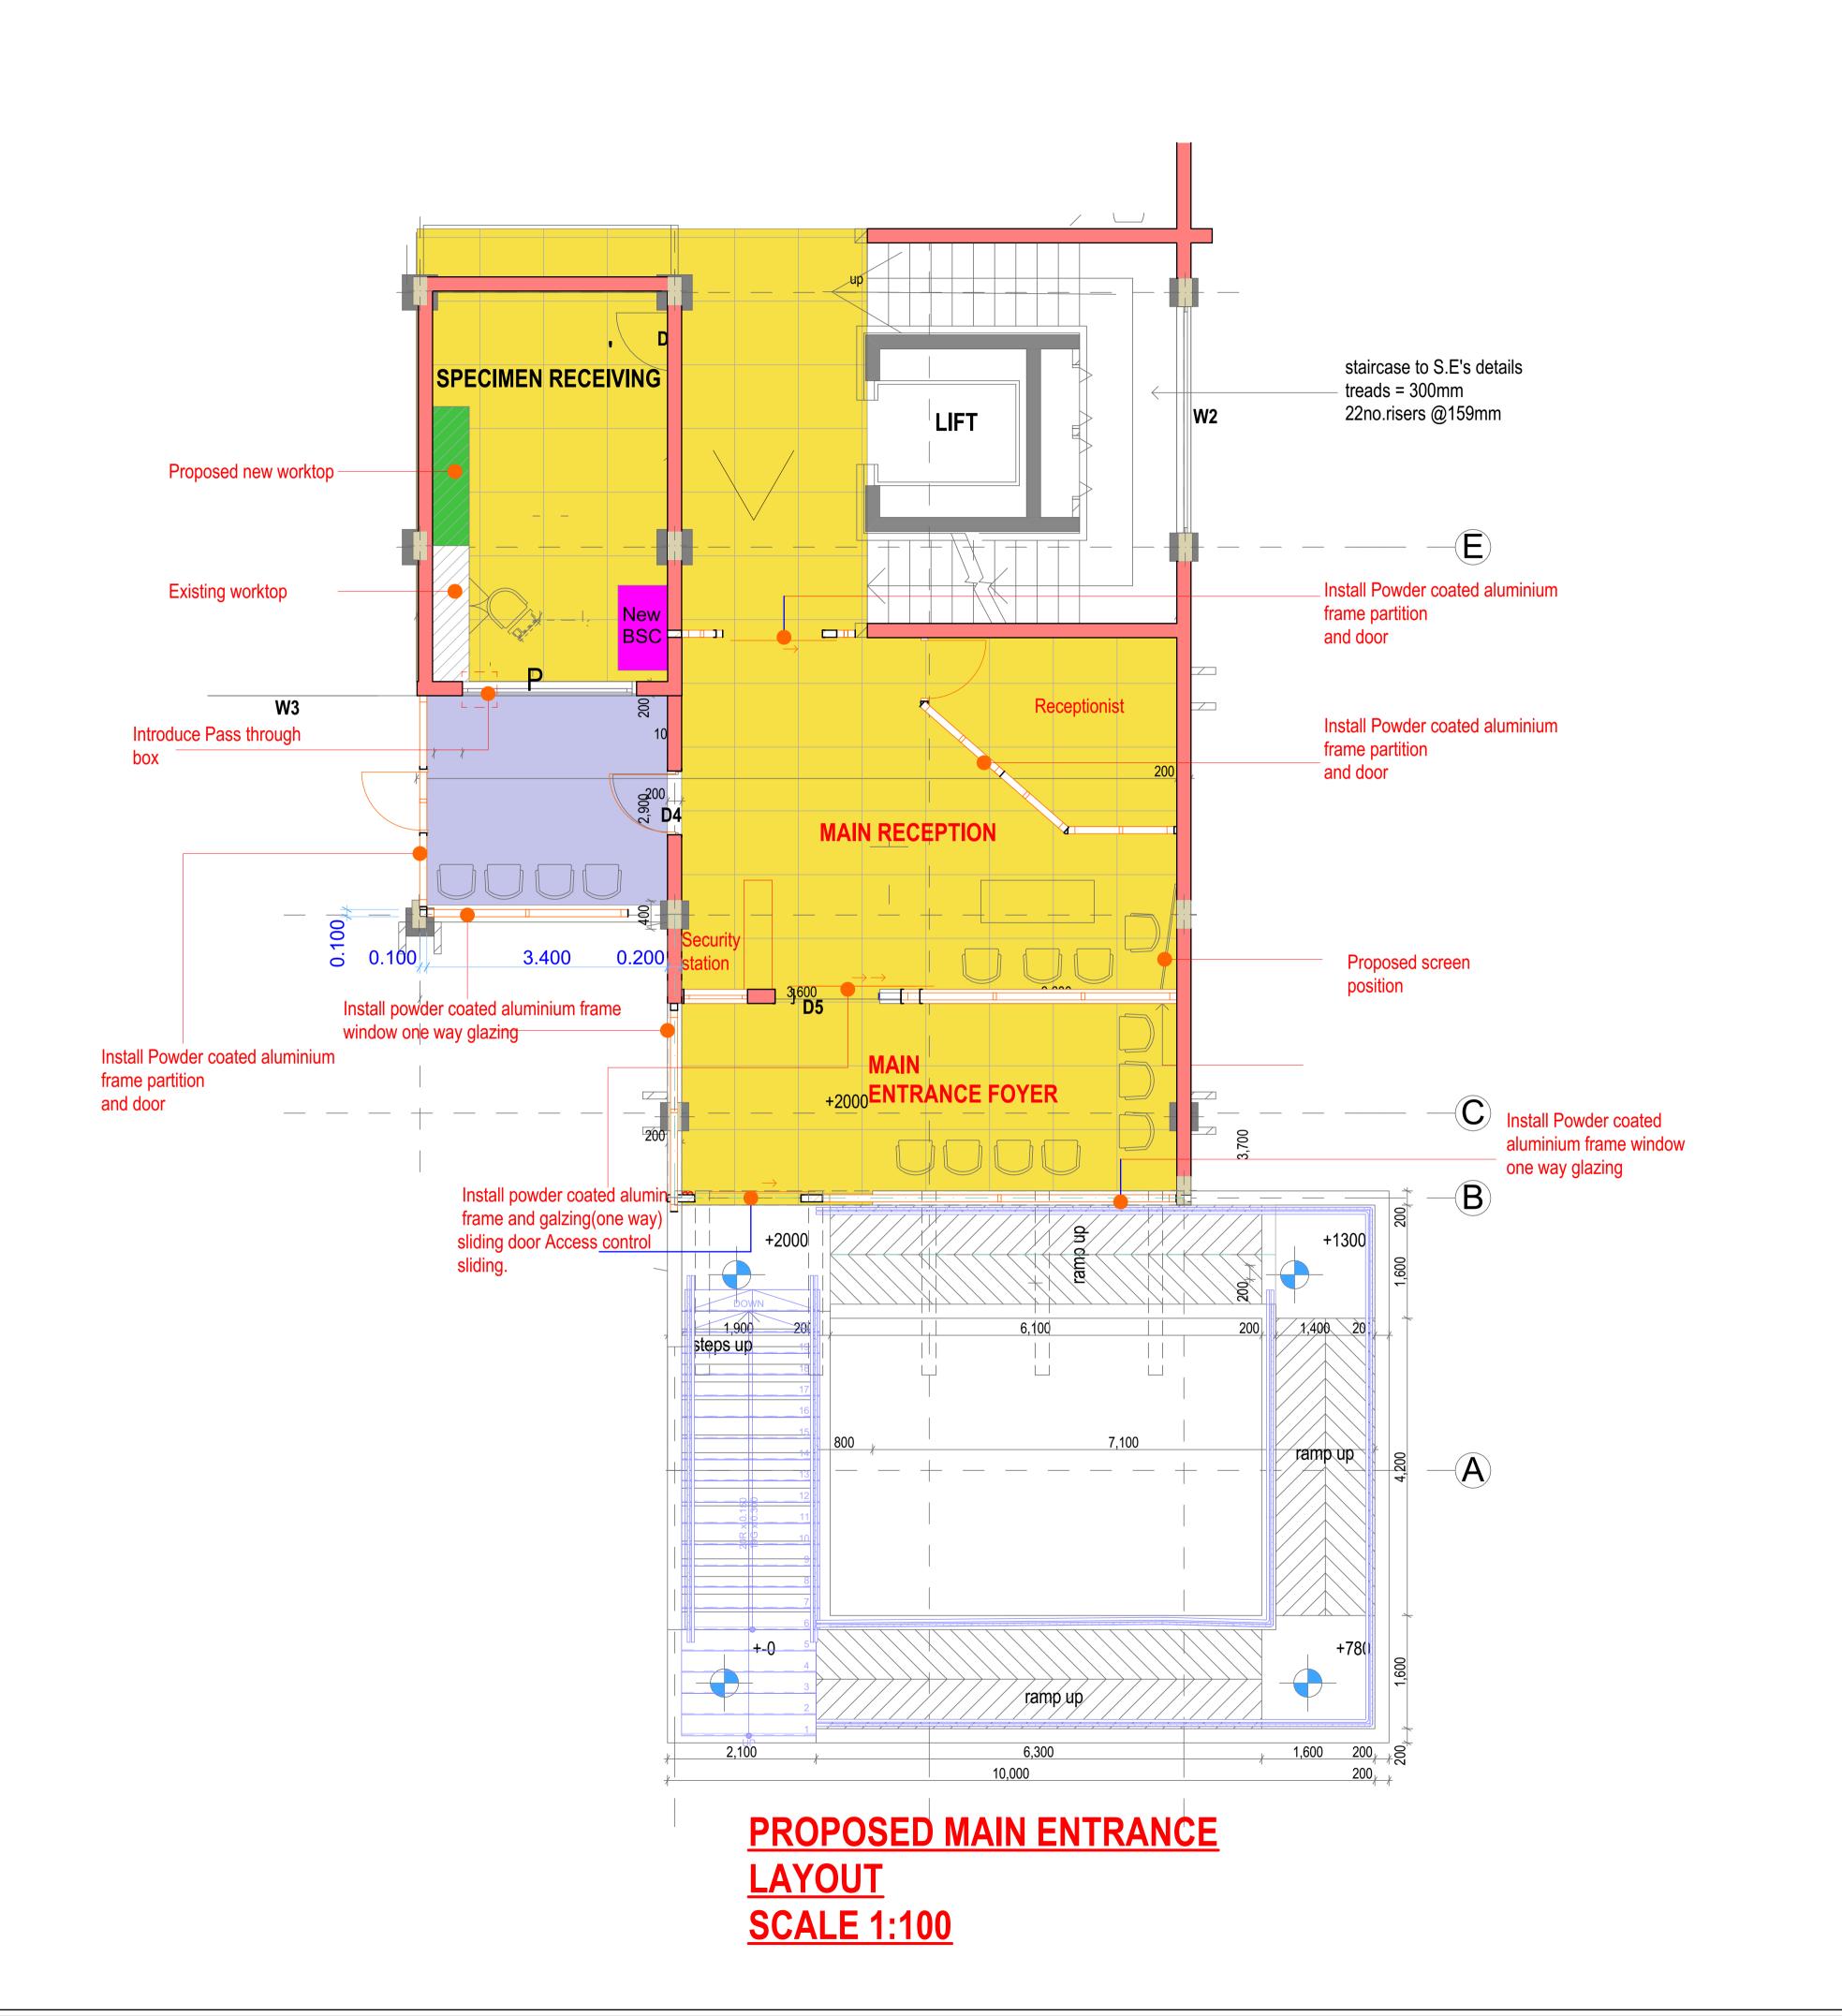

ARCHITECTURAL NOTES.

- 1. All works to be carried out in accordance with Local
- Authority regulations.

 2. All figured dimensions to be taken in preference
- to scaled dimensions.
- 3. All walls below 200mm to be reinforced with hoop
- iron at every alternative course. 4. Provide damp proof course (D.P.C.) under all walls.
- 5. P.V. indicates permanent ventilations.
 6. All drainage passing under building and drive area to be of pvc pipe and encased in 150mm thick concrete surround.
 7. All inspection chambers in drive area to have

- heavy duty covers. 8. Check all dimensions on site.
- 9. All sanitary work to be in accordance with MOH rules
- and regulations and NCC requirements.

 10. 500g polythene sheeting and anti-termite treatment
- to be provided under ground floor concrete slab.

 11. All reinforced concrete works to Structural Eng. detail.
- 12. Automatic booster pump for FHRs to be provided to the satisfaction of the Chief Fire Officer.
- 13. 4500 litres reserve for hose reel
- 14. Electrical fire alarm system to the approval of Chief Fire Officer. 15. Fire alarm and booster to be provided with
- secondary power supply.

 16. 2x9 kg Dry Powder Fire Extinguishers at areas shown.
- 17. 2x9 litre water and 1x4.5 kg CO2 fire extinguishers

	. 9
to be provided per floor.	
to be provided per 11001.	

Revision	Date

Architects signature...

NATIONAL PUBLIC HEALTH LABORATORY, DEPARTMENT OF LABORATORY SERVICES (DLS), MINISTRY OF HEALTH P.O. BOX 20750-00202,

LETRA DESIGNS LIMITED

P.O BOX 12814-20100 NAKURU

TEL: +254729528772 EMAIL:info@tetradesigns.co.ke

MANAGED BY

AMREF HEALTH AFRICA IN KENYA P.O BOX 30125-00100 WILSON AIRPORT,

Client sign

Project Title

PROPOSED RENOVATION AND MAINTENANCE OF BSL III LABORATORIES AT NATIONAL PUBLIC HEALTH LABORATORY (BLOCK B) AT THE DEPARTMENT OF LABORATORY SERVICES, MINISTRY OF HEALTH.

KENYATTA NATIONAL HOSPITAL GROUNDS -OFF NGONG ROAD

Project No.TD/NKU/22/04/125 **Drawing Title**

GROUND FLOOR

GROUND FLOOR PLINTH AREA:

Drawing Status

WORKING DRAWINGS

Drawn by Renovations/Design by Checked by Arch. Boaz. Kim JAN,2025

Scales

Drawing Number

1:100

Status Revision

Refer to BSL 3 First floor Blow up plan **HIV SEROLOGY** Corrian Toplad Plus benchtop finish on **EID Service** 25x25mm RHS frames with Corrian Toplab Plus benchtop finish on 25x25mm RHS frames with movable cabinets under to details movable cabinets under to details /// D9B fully fixed glazing on powder coated aluminium frames 1,200 2,400 is ROOM 2 **SEROLOGY** BSL 3 LABORATORY D9B ^V ANTE SPECIMEN RECEIVING/ ACCESSIONING internal R.C columns to be VITEK 2 clad in MDF panels to 1400mmm CHEMICALS CLEANERS WASTE BSC 4 Staging area ducts D12 staircase to S.E's detail staircase to S.E's details with MDF pigeon holes under to treads = 300mm 22no.risers @159mm LIFT 22no.risers @159mm FHR D11 Areas to be worked on labelled in red BSC 4 --1,400 1,645 150 DR testing sample fully fixed glazing on powder coat coated aluminium frames hooks CHEMISTRY DATA ENTRY HAEMATOLOGY VIROLOGY _Cargo lift to specifications curtain glazing wall in anodised aluminium frame to detail tinted panes with powder coated

FIRST FLOOR LAYOUT SCALE 1:100

SUMMARY OF RENOVATION WORKS AT FIRST FLOOR LEVEL

Replace the indicated fourteen wash hand basin taps to elbow operated taps.

Carefully remove all the existing dilapidated epoxy floor finish including the underlying poor cement sand screed and dispose off the debries. Prepare the surface and install Epoxy floor finish according to manufactures requirements and as per the attached builders work specifications.

Introduce a cargo lift at the indicated area on the plan layout as per the attached builders work specifications.

Inspect for any cracked, broken or loose tiles, remove and dispose of the debries. Replace/fix tiles as per the attcahed builders work specifications and make good any affected walling, plaster work or paintwork.

Inspect for any existing cracks and repair as per the procedure in the specifications.

Inspect drainage pipeworks and AC ductwork along the ceiling and wall for any leakages indicated and not indicated, and repair accordingly, making good any affected walling, plaster work, ceiling panels or paint work as a result of leakages repair.

Inspect all aluminium windows for any locking and opening problems and repair accordingly as per the specifications.

Inspect all wooden doors locking mechanism and repair accordingly.Introduce an access control door from the main reception as indicated.

Specific BSL 3 renovation works as per the attached URS specifications.

Other works and details as per the attached User requirements Specifications.

LEGEND

Area nigniight

Areas where no action is to be taken labelled in black

Floor tiles finish cover area
Epoxy floor finish cover area
Leakages
Bench top to be finished to BSL standards
Bench section to be demolished to accommodate additional equipment/equipments access
Step over bench to BSL 3 ante room requirements

2 tier rack/shelve to BSL3 Standards

Cabinets/shelves for PPES, PCR/ Emergency kits to BSL3 Ante room Standards

Marked wash hand basin taps to be changed

C-BSC - CLEAN BIOSAFETY CABINET D-BSC - DIRTY BIOSAFETY CABINET B6 - BSC 6ft. B4 - BSC 4ft. HWS - HANDWASH SINK

S - SINK F - FRIDGE Fr. - FREEZER

I - INCUBATOR C - CENTRIFUGE 960 - MGT960

P - PASS THROUGH INCLUDING SPECIMEN PLACEMENT BASE TO REQUIREMENTS E - EQUIPMENT DOOR

W - VIEWING SEALED WINDOW SH - SHOWER **EEW-EMERGENCY EYE WASH ESH-EMERGENCY SHOWER** DR - DRAWERS A - AUTOCLAVE

PL - PRINTER LABEL HB - HIGH BENCH _1050mm high LB - LOW BENCH 900mm high

E.O.T.ELBOW OPERATED TAPS

F A- FREE STANDING AUTOCLAVE

ARCHITECTURAL NOTES.

- 1. All works to be carried out in accordance with Local
- Authority regulations.
 2. All figured dimensions to be taken in preference to scaled dimensions.
- 3. All walls below 200mm to be reinforced with hoop
- iron at every alternative course. 4. Provide damp proof course (D.P.C.) under all walls.
- 5. P.V. indicates permanent ventilations. 6. All drainage passing under building and drive area to be of pvc pipe and encased in 150mm
- thick concrete surround.
- 7. All inspection chambers in drive area to have heavy duty covers.
- 8. Check all dimensions on site. 9. All sanitary work to be in accordance with MOH rules and regulations and NCC requirements.
- 10. 500g polythene sheeting and anti-termite treatment to be provided under ground floor concrete slab.
- 11. All reinforced concrete works to Structural Eng. detail.
- 12. Automatic booster pump for FHRs to be provided to
- the satisfaction of the Chief Fire Officer. 13. 4500 litres reserve for hose reel
- 14. Electrical fire alarm system to the approval of Chief Fire Officer.
- 15. Fire alarm and booster to be provided with
- secondary power supply.

 16. 2x9 kg Dry Powder Fire Extinguishers at areas shown.
- 17. 2x9 litre water and 1x4.5 kg CO2 fire extinguishers to be provided per floor.

Date

Architects sig	gnature		
Client			
NATIONAL PUBLIC HE LABORATORY SERVIC P.O. BOX 20750- 00202 NAIROBI.	ES (DLS), MINIS	ORY, DEPAI TRY OF HE	RTMENT OF ALTH
MANAGED BY	,		
AMREF HEALTH AFRIC P.O BOX 30125-00100 WILSON AIRPORT, NAIROBI.			
Client sign			
PROPOSED RENOVATION NATIONAL PUBLIC HEALT LABORATORY SERVICES,	TH LABORATORY (BLOCK B) A	
ON KENYATTA NATIONAL HO	SPITAL GROUNDS	-OFF NGON	G ROAD
Project No.TD/NKL Drawing Title			
		OOR	
	FIRST FL		
FIRST FLOOR PLINTH AR	EA:		
Drawing Status			
WORKING	DRAWIN	GS	
Drawn by Renovation			by Date

Scales

Drawing Number

1:100

Status

Revision

SUMMARY OF RENOVATION WORKS AT SECOND FLOOR LEVEL iron at every alternative course. 4. Provide damp proof course (D.P.C.) under all walls. Replace the indicated eight wash hand basin taps to elbow operated taps. 5. P.V. indicates permanent ventilations. 6. All drainage passing under building and drive area to be of pvc pipe and encased in 150mm Carefully remove all the existing dilapidated epoxy floor finish including the underlying thick concrete surround. 7. All inspection chambers in drive area to have poor cement sand screed and dispose off the debries. Prepare the surface and install heavy duty covers. Epoxy floor finish according to manufactures requirements and as per the attached 8. Check all dimensions on site. 9. All sanitary work to be in accordance with MOH rules builders work specifications. and regulations and NCC requirements. 10. 500g polythene sheeting and anti-termite treatment to be provided under ground floor concrete slab. Introduce a cargo lift at the indicated area on the plan layout as per the attached builders All reinforced concrete works to Structural Eng. detail. 12. Automatic booster pump for FHRs to be provided to work specifications. Refer to Decontamination room the satisfaction of the Chief Fire Officer. 13. 4500 litres reserve for hose reel Refer to BSL 3 second floor proposed changes 14. Electrical fire alarm system to the approval of Chief Fire Officer. Inspect for any cracked, broken or loose tiles, remove and dispose of the debries. 15. Fire alarm and booster to be provided with Blow up plan Blow up plan Replace/fix tiles as per the attcahed builders work specifications and make good any secondary power supply. 16. 2x9 kg Dry Powder Fire Extinguishers at areas shown. L[- -]11 affected walling, plaster work or paintwork. 17. 2x9 litre water and 1x4.5 kg CO2 fire extinguishers to be provided per floor. Inspect for any existing cracks and repair as per the procedure in the specifications. Date Inspect drainage pipeworks and AC ductwork leakages, concrete gutters overflow, ingress Revision through windows or openings, along the ceiling and wall, analyse the cause and repair FREEZER accordingly, making good any affected walling, plaster work, ceiling panels or paint work Corrian Toplab Plus benchtop finish or ROOM 25mm RHS frames with as a result of leakages or its repair. Check all areas not only indicated areas. novable cabinets under to details Inspect all aluminium windows for any locking and opening problems and repair -Air tight windows-STORE accordingly. **NEW LABORATORY** 1,750 TOM BE CREATED 6 tier full height fully fixed glazing on powder blockboard Inspect all wooden doors locking mechanism and repair accordingly. coated aluminium framed window shelving to details Specific BSL 3 renovation works as per the attached URS. sorting out of DECONTAMINATION Other works as per the attached user requirement specifications. pressure gaug Area highlight AREA Areas to be worked on labelled in red specimen sorting internal R.C columns to be clad in MDF panels to 1400mmm Areas where no action is to be taken labelled in black BSL 2 LABORATORY Floor tiles finish cover area Epoxy floor finish cover area Bench top to be finished to BSL standards FIRE ESCAPE STAIRCASE staircase to S.E's details Bench section to be demolished to accommodate treads = 300mm 800x600mm waste **D11** additional equipment/access for equipment 22no.risers @159mm Stainless steel balustrading to approved sample Step over bench to BSL 3 ante room requirements W.C's 2 tier rack/shelve to BSL3 Standards SPECIMEN PREP Cabinets/shelves for PPES, PCR/ Emergency kits to BSL3 Ante room Standards CLEAN ROOM PCR 3 (=.07) Marked wash hand basin taps to be changed C-BSC - CLEAN BIOSAFETY CABINET double drainer D-BSC - DIRTY BIOSAFETY CABINET B6 - BSC 6ft. B4 - BSC 4ft. HWS - HANDWASH SINK HEAD NTRL S - SINK F - FRIDGE Fr. - FREEZER - INCUBATOR curtain glazing wall in C - CENTRIFUGE frame to detail 960 - MGT960 P - PASS THROUGH INCLUDING SPECIMEN PLACEMENT BASE TO REQUIREMENTS E - EQUIPMENT DOOR W - VIEWING SEALED WINDOW L[- -]09 aluminium framing SH - SHOWER Corrian Toplab Plus benchtop finish on EEW-EMERGENCY EYE WASH 25x25mm RHS frames with **ESH-EMERGENCY SHOWER** DR - DRAWERS A - AUTOCLAVE PL - PRINTER LABEL HB - HIGH BENCH _1050mm high LB - LOW BENCH_ 900mm high E.O.T.ELBOW OPERATED TAPS F A- FREE STANDING AUTOCLAVE WORKING DRAWINGS Drawn by Renovations/Design by Checked by Arch. Boaz. Kim JAN,2025 SECOND FLOOR LAYOUT Scales 1:100 **SCALE 1:100**

ARCHITECTURAL NOTES.


- 1. All works to be carried out in accordance with Local
- Authority regulations.
 2. All figured dimensions to be taken in preference
- to scaled dimensions.
- 3. All walls below 200mm to be reinforced with hoop

TEL: +2547295	I-20100 NAKURI 28772 etradesigns.co.ke
Client sign	
Project Title	
PROPOSED RENOVATION AND MAINTENANCE OF BSL II NATIONAL PUBLIC HEALTH LABORATORY (BLOCK B) A' LABORATORY SERVICES, MINISTRY OF HEALTH.	II LABORATORIES AT ITHE DEPARTMENT OF
ON	
KENYATTA NATIONAL HOSPITAL GROUNDS -OFF NGON	G ROAD
Project No.TD/NKU/22/04/125	
Drawing Title	
SECOND FLOOR	
SECOND FLOOR PLINTH AREA:	
SECOND FLOOR PLINTH AREA: Drawing Status	

Drawing Number

Status

Revision

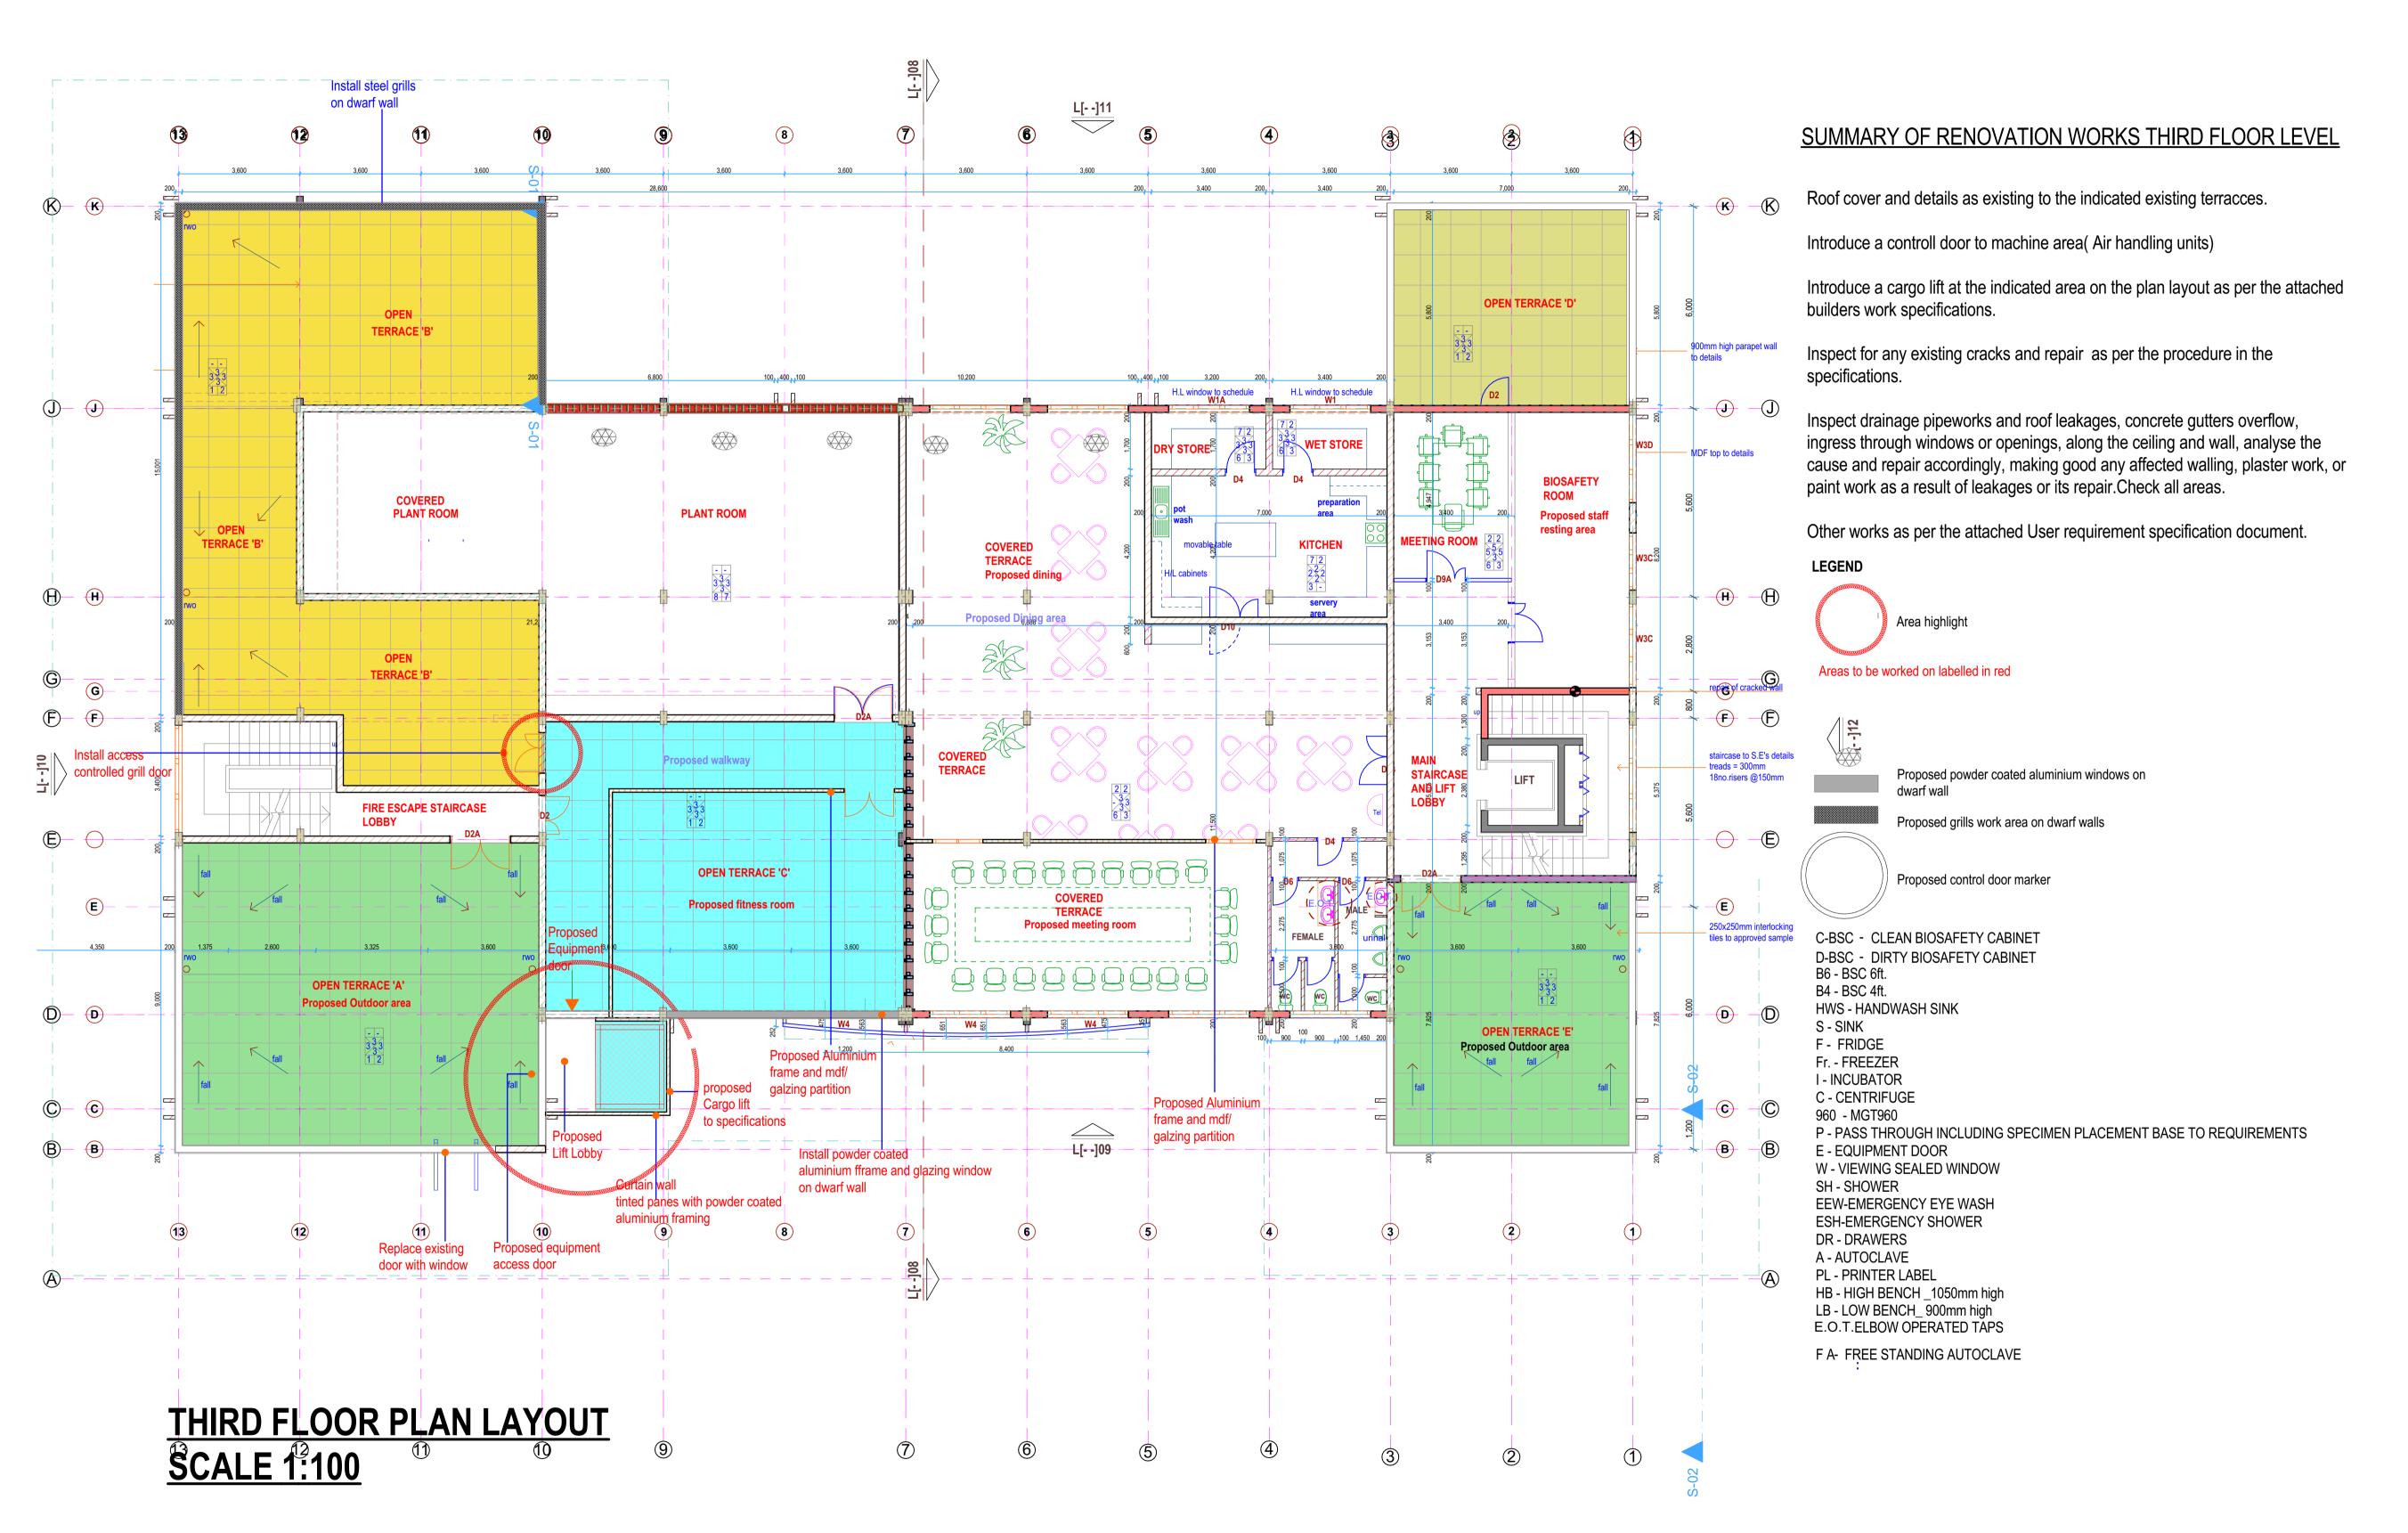

ARCHITECTURAL NOTES.

- All works to be carried out in accordance with Local Authority regulations
- Authority regulations.
 2. All figured dimensions to be taken in preference
- to scaled dimensions.

 3. All walls below 200mm to be reinforced with boor
- 3. All walls below 200mm to be reinforced with hoop iron at every alternative course.
- iron at every alternative course.

 4. Provide damp proof course (D.P.C.) under all walls.
- 5. P.V. indicates permanent ventilations.

 6. All drainage passing under building, and drive.
- All drainage passing under building and drive area to be of pvc pipe and encased in 150mm thick concrete surround.
- 7. All inspection chambers in drive area to have heavy duty covers.
- 8. Check all dimensions on site.9. All sanitary work to be in accordance with MOH rules
- and regulations and NCC requirements.10. 500g polythene sheeting and anti-termite treatment
- to be provided under ground floor concrete slab.
- 11. All reinforced concrete works to Structural Eng. detail.
- 12. Automatic booster pump for FHRs to be provided to the satisfaction of the Chief Fire Officer.
- 13. 4500 litres reserve for hose reel14. Electrical fire alarm system to the approval of Chief Fire Officer.
- 15. Fire alarm and booster to be provided with
- secondary power supply.

 16. 2x9 kg Dry Powder Fire Extinguishers at areas shown.
- 17. 2x9 litre water and 1x4.5 kg CO2 fire extinguishers to be provided per floor.

Revision	Date



Architects signature....

NATIONAL PUBLIC HEALTH LABORATORY, DEPARTMENT OF LABORATORY SERVICES (DLS), MINISTRY OF HEALTH P.O. BOX 20750-00202, NAIROBI.

AMREF HEALTH AFRICA IN KENYA

P.O BOX 30125-00100 WILSON AIRPORT, NAIROBI.

Client sign...

Project Title
PROPOSED RENOVATION AND MAINTENANCE OF BSL III LABORATORIES AT
NATIONAL PUBLIC HEALTH LABORATORY (BLOCK B) AT THE DEPARTMENT OF

ON

KENYATTA NATIONAL HOSPITAL GROUNDS -OFF NGONG ROAD

LABORATORY SERVICES, MINISTRY OF HEALTH.

Project No.TD/NKU/22/04/125

Drawing Title

THIRD FLOOR

THIRD FLOOR PLINTH AREA:

Drawing Status

WORKING DRAWINGS

Drawn by Renovations/Design by Checked by


Arch. Boaz. Kim JAN,2025


Scales

Drawing Number

1:100

Status Revision

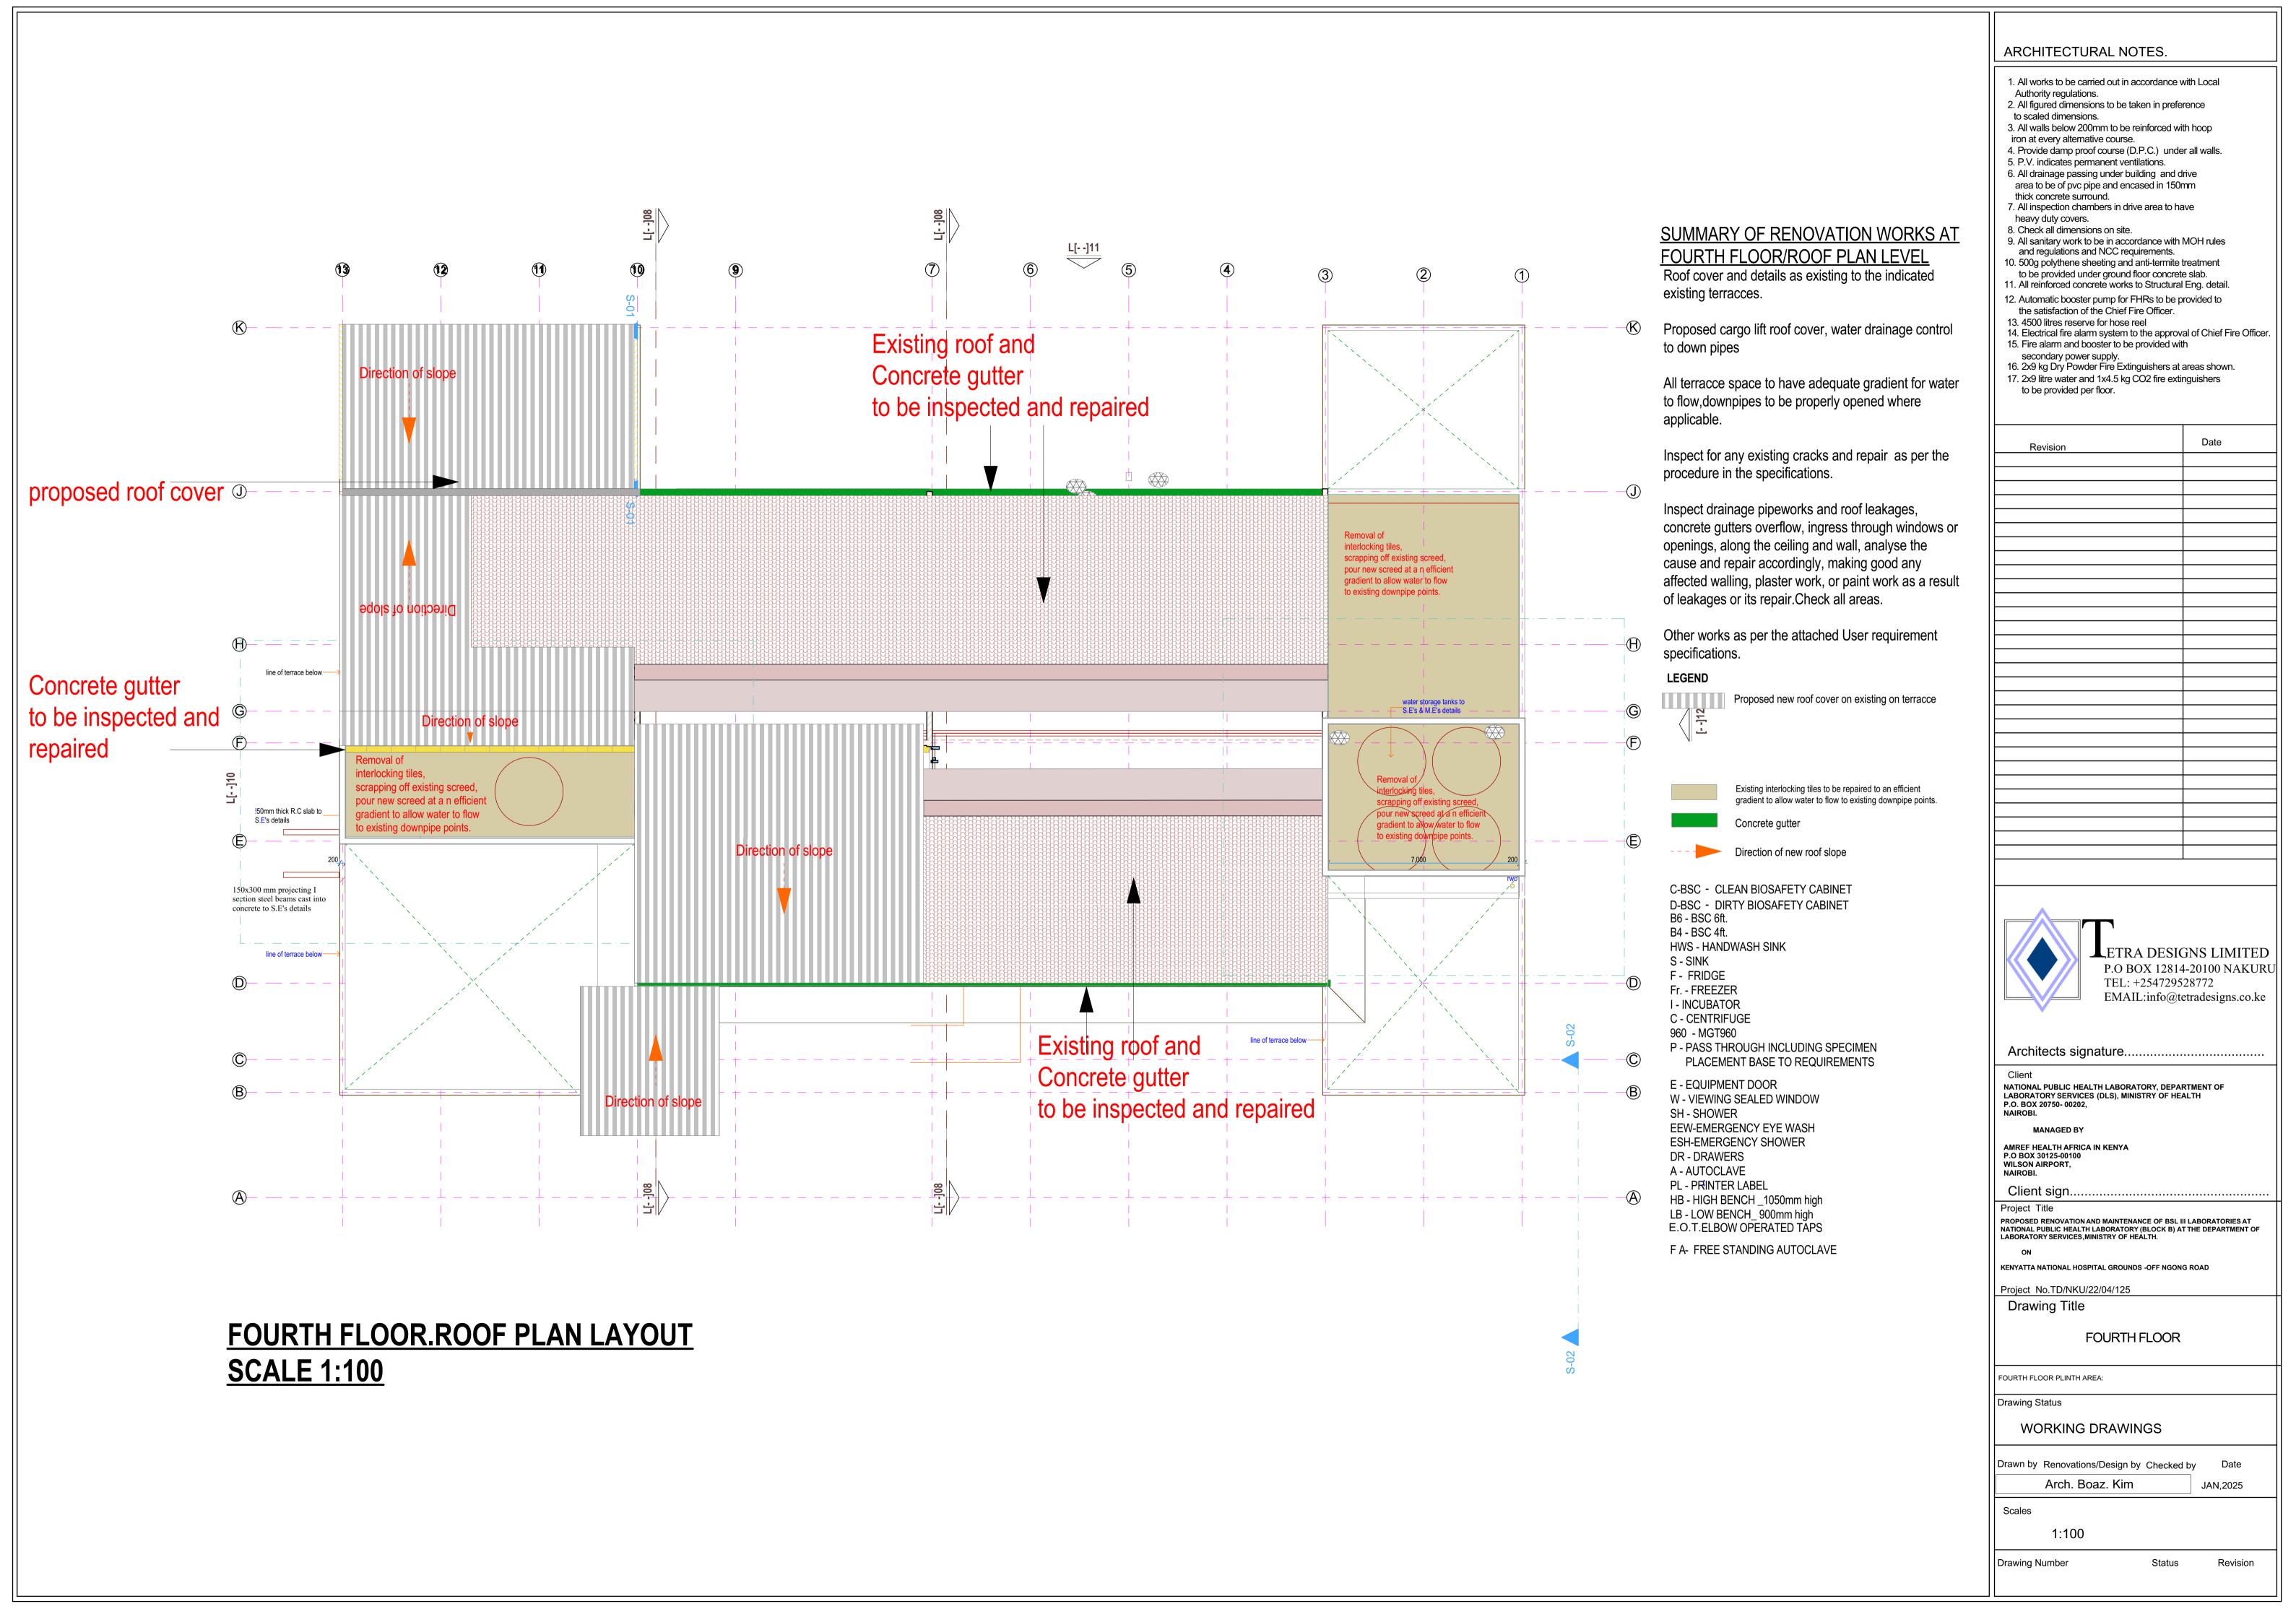

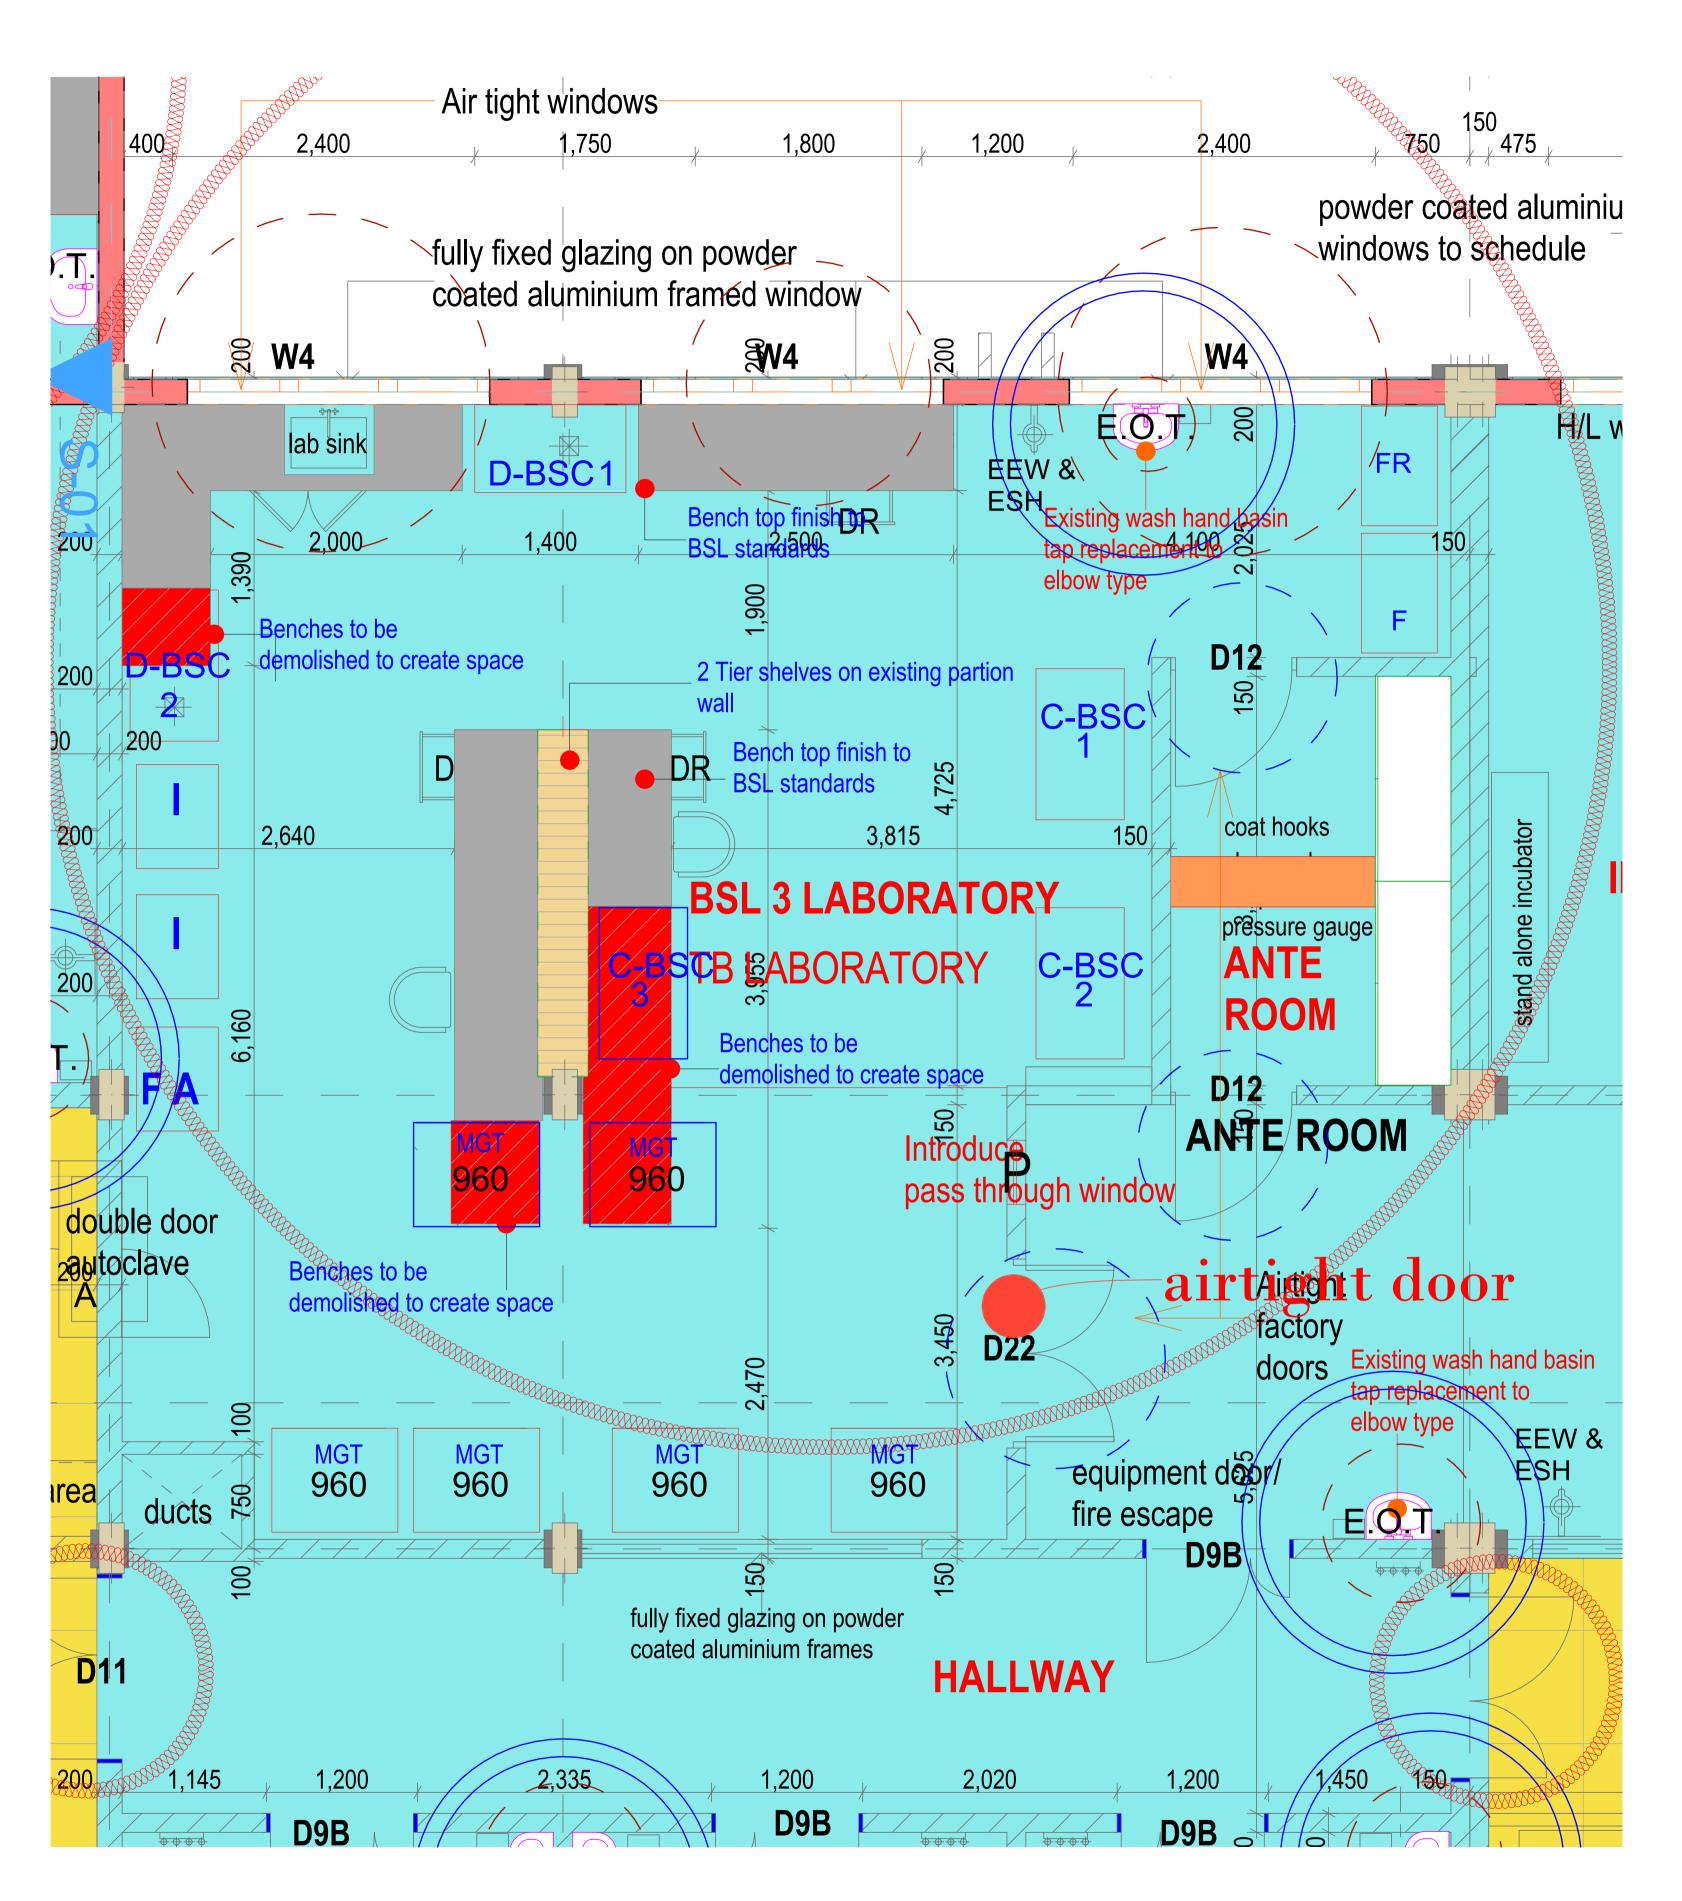

BSL 3 FLOOR PLAN LAYOUT(SECOND FLOOR) **SCALE 1:100**

SUMMARY OF RENOVATION WORKS IN BSL3 AT SECOND FLOOR LEVEL

Carefully remove all the existing dilapidated epoxy floor finish including the underlying poor cement sand screed and dispose off the debries. Prepare the surface and install Epoxy floor finish according to manufactures requirements and as per the attached builders work specifications or an equivalent floor finish that cost effcetive, durable, chemical resistant and easy to clean.

Inspect for any existing cracks and repair as per the procedure in the specifications.

Inspect for drainage/supply pipework leakages, water ingress through windows or openings, along the ceiling and wall, analyse the root cause and repair accordingly, making good any affected walling, plaster work, or paint work as a result of leakages or its repair. Check all areas within the BSL3.

Inspect and ensure that the dilution trap under the laboratory sink exists and /or is fully functional in treatment of the laboartory waste before connecting to the main drainage line.

Carefully Remove part of the benches as indicated in the layout and dispose off to accommodate additional equipment, making good all the affected areas.

Carefully stripping off the peeling of wall and ceiling paintwork, prepare the surface and apply epoxy paint as per the manufacturers requirements to suit BSL3, or wall and ceiling finish that is functional equivalent in a BSL3 that is cost effective, durable, chemical resistant and easy to clean.

Replace the existing worktop/bench finish with either epoxy or functionally equivalent finish in a BSL3 bech finish that is cost effective, durable, chemical rsistant and easy to

lintroduce a pass through window at the indicated area in the layout.

Inspect and ensure that the existing aluminium windows are airtight.

Inspect and ensure that the equipment access door and ante room doors are airtight., or can be repaired to be airtight or replaced with airtight doors of similar sizes applicable within BSL3 and ante room.

Introduce applicable storage cabinets and step over bench in the ante room at the areas indicated in the layout.

Other works as per the attached URS

LEGEND Floor tiles finish cover area Epoxy floor finish cover area Bench top finish to be cost effective, durable, chemical resistant and easy to clean Bench section to be carefully demolished and carefully disposed off to accommodate additional equipment. 1600mm long x 400mm wide x 400mm high and fully open on one side for shoe storage Stainless steel stepover bench or equivalent 2750mm long x400mm wide x 600mm high stainless steel shelve. 3200mm long x 600mm wide x 2100mm high Stainless steel cupboard for PPES, PCR/ Emergency kits storage Marked wash hand basin tap to be changed or supply or drainage pipe leakages to be inspected

D-BSC - DIRTY BIOSAFETY CABINET B6 - BSC 6ft. B4 - BSC 4ft.

C-BSC - CLEAN BIOSAFETY CABINET

HWS - HANDWASH SINK

S - SINK

F - FRIDGE Fr. - FREEZER

I - INCUBATOR

C - CENTRIFUGE

960 - MGT960

P - PASS THROUGH INCLUDING SPECIMEN PLACEMENT BASE TO REQUIREMENTS

E - EQUIPMENT DOOR W - VIEWING SEALED WINDOW

SH - SHOWER

EEW-EMERGENCY EYE WASH

ESH-EMERGENCY SHOWER

DR - DRAWERS

A - AUTOCLAVE

PL - PRINTER LABEL HB - HIGH BENCH _1050mm high

LB - LOW BENCH_ 900mm high

E.O.T.ELBOW OPERATED TAPS

F A- FREE STANDING AUTOCLAVE

ARCHITECTURAL NOTES.

- 1. All works to be carried out in accordance with Local
- Authority regulations. 2. All figured dimensions to be taken in preference
- to scaled dimensions. 3. All walls below 200mm to be reinforced with hoop
- iron at every alternative course.
- 4. Provide damp proof course (D.P.C.) under all walls. 5. P.V. indicates permanent ventilations.
- 6. All drainage passing under building and drive area to be of pvc pipe and encased in 150mm
- thick concrete surround.
- 7. All inspection chambers in drive area to have
- heavy duty covers. 8. Check all dimensions on site.
- 9. All sanitary work to be in accordance with MOH rules and regulations and NCC requirements.
- 500g polythene sheeting and anti-termite treatment to be provided under ground floor concrete slab.
- All reinforced concrete works to Structural Eng. detail
- 12. Automatic booster pump for FHRs to be provided to
- the satisfaction of the Chief Fire Officer.
- 13. 4500 litres reserve for hose reel
- 14. Electrical fire alarm system to the approval of Chief Fire Officer. 15. Fire alarm and booster to be provided with
- secondary power supply.

 16. 2x9 kg Dry Powder Fire Extinguishers at areas shown.
- 17. 2x9 litre water and 1x4.5 kg CO2 fire extinguishers
- to be provided per floor.

Revision

Date

LETRA DESIGNS LIMITED P.O BOX 12814-20100 NAKURU

TEL: +254729528772

EMAIL:info@tetradesigns.co.ke

Architects signature. NATIONAL PUBLIC HEALTH LABORATORY, DEPARTMENT OF LABORATORY SERVICES (DLS), MINISTRY OF HEALTH

MANAGED BY

AMREF HEALTH AFRICA IN KENYA WILSON AIRPORT,

P.O. BOX 20750-00202,

Client sign Project Title PROPOSED RENOVATION AND MAINTENANCE OF BSL III LABORATORIES AT NATIONAL PUBLIC HEALTH LABORATORY (BLOCK B) AT THE DEPARTMENT OF

KENYATTA NATIONAL HOSPITAL GROUNDS -OFF NGONG ROAD

Project No.TD/NKU/22/04/125

Drawing Title

BSL 3 FLOOR PLAN ALYOUT(SECOND FLOOR)

FOURTH FLOOR PLINTH AREA:

Drawing Status

Scales


WORKING DRAWINGS

Drawn by Renovations/Design by Checked by Arch. Boaz. Kim JAN,2025

1:100

Status Revision

Drawing Number

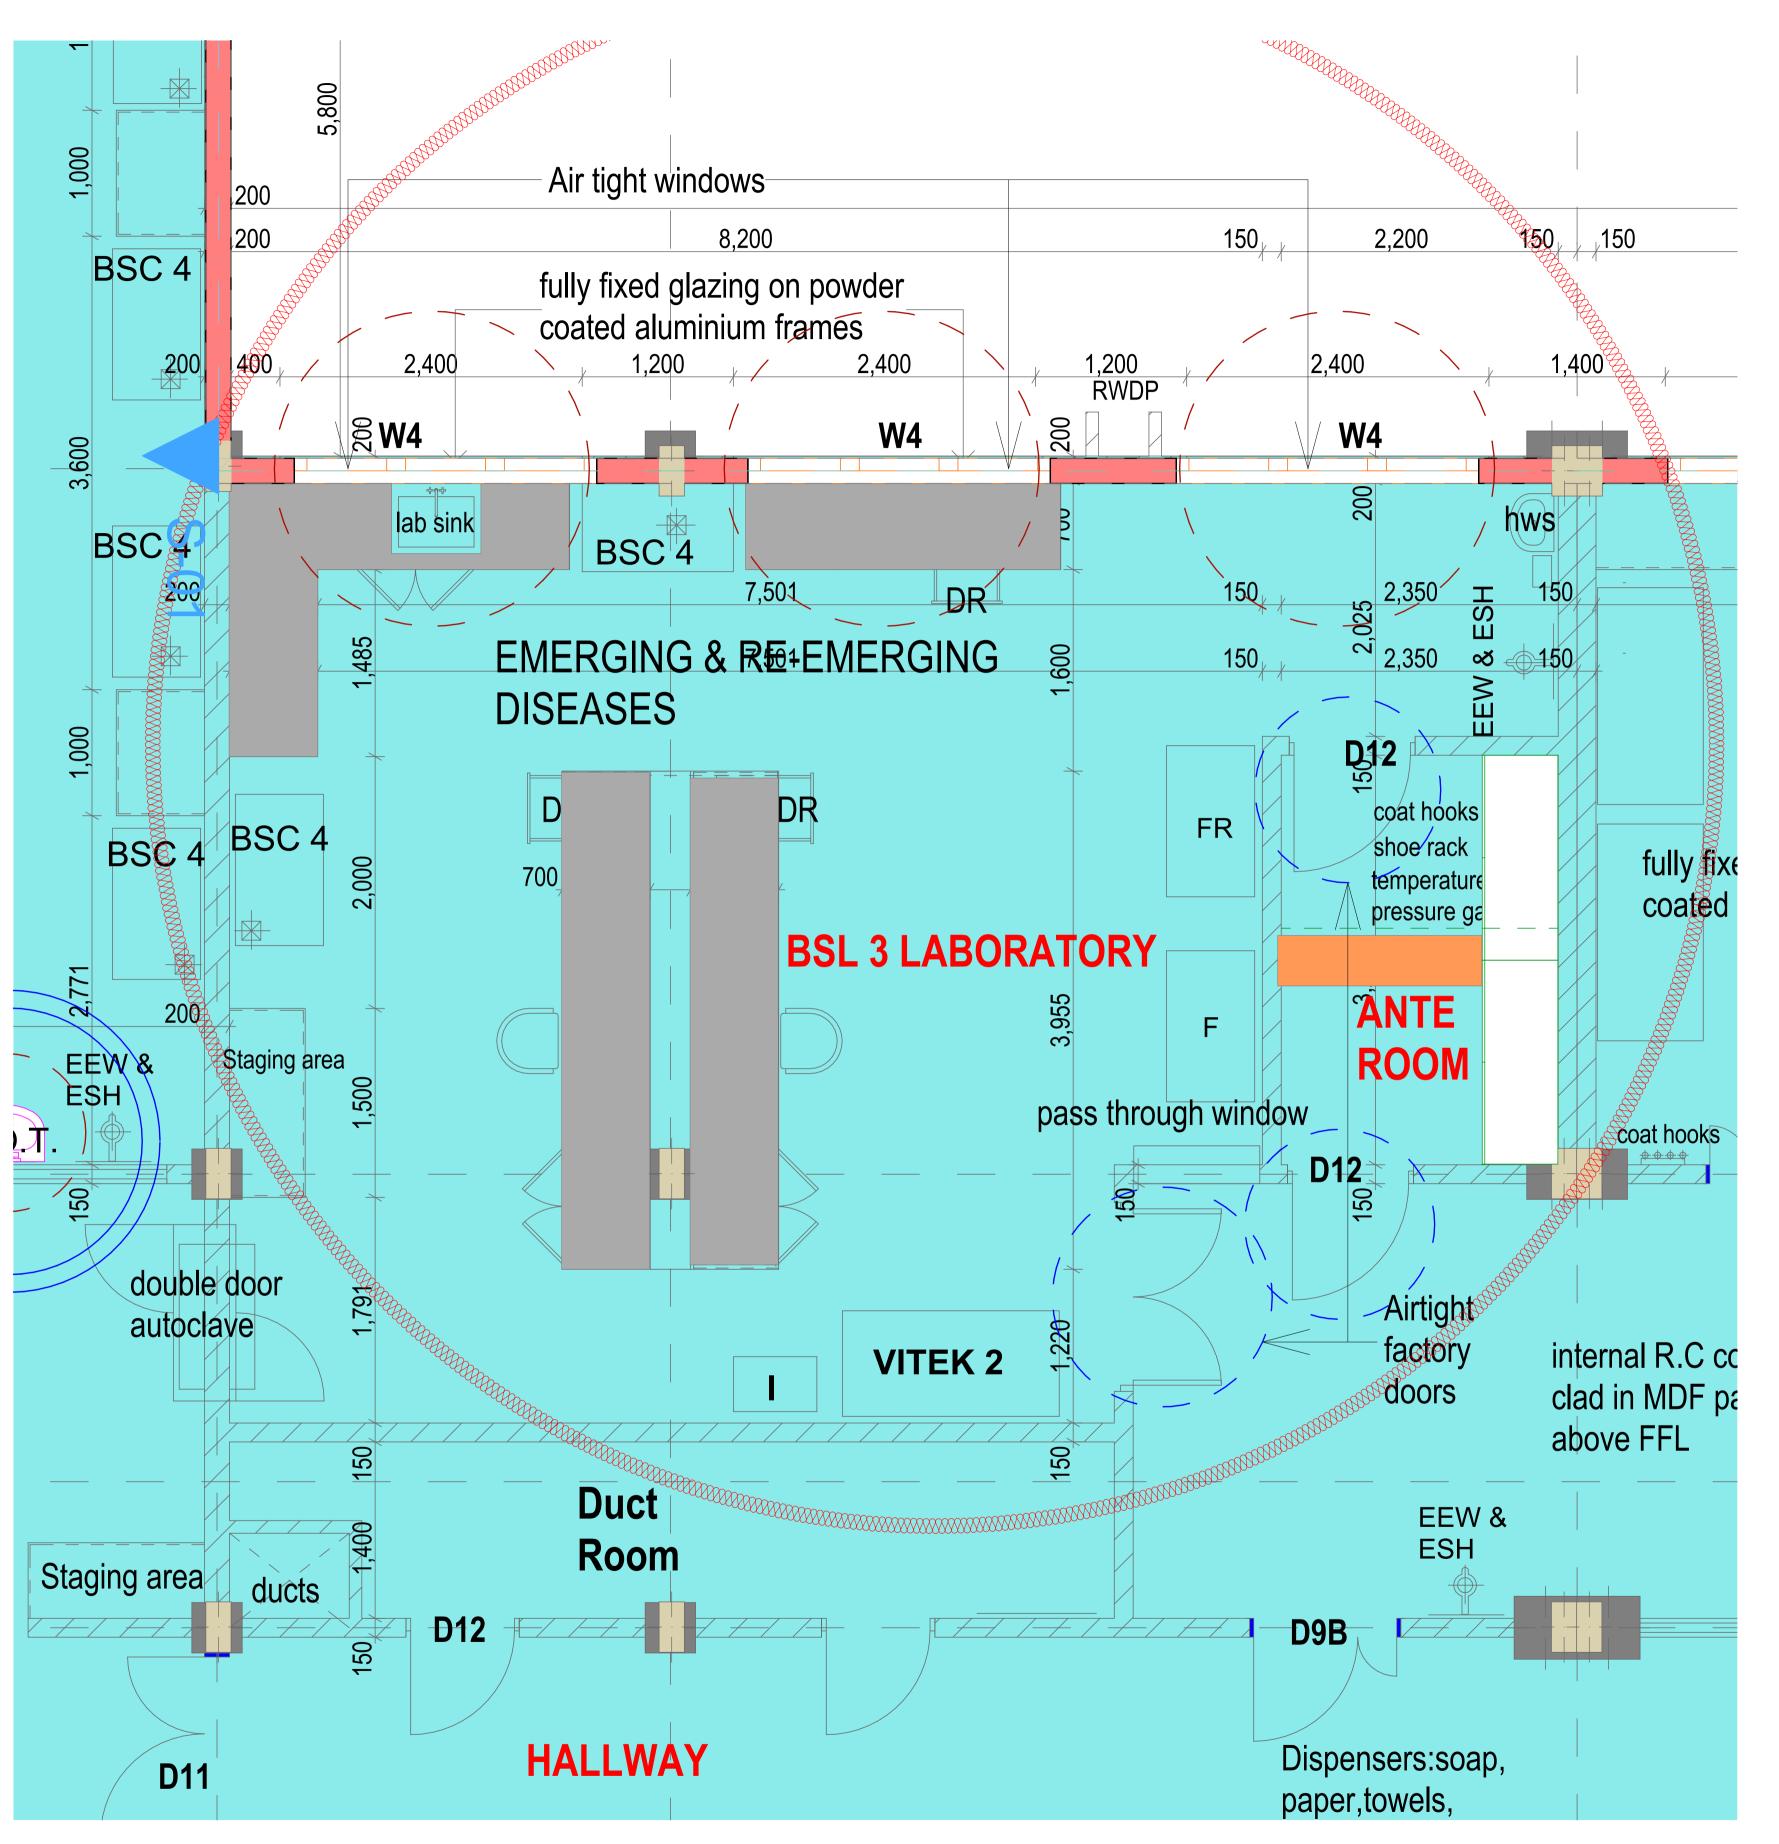

BSL 3 FLOOR PLAN LAYOUT(FIRST FLOOR) **SCALE 1:100**

SUMMARY OF RENOVATION WORKS IN BSL3 AT FIRST FLOOR LEVEL

Carefully remove all the existing dilapidated epoxy floor finish including the underlying poor cement sand screed and dispose off the debries. Prepare the surface and install Epoxy floor finish according to manufactures requirements and as per the attached builders work specifications or an equivalent floor finish that cost effcetive, durable, chemical resistant and easy to clean.

Inspect for any existing cracks and repair as per the procedure in the specifications.

Inspect for drainage/supply pipework leakages, water ingress through windows or openings, along the ceiling and wall, analyse the root cause and repair accordingly, making good any affected walling, plaster work, or paint work as a result of leakages or its repair. Check all areas within the BSL3.

Inspect and ensure that the dilution trap under the laboratory sink exists and /or is fully functional in treatment of the laboartory waste before connecting to the main drainage line.

Carefully stripping off the peeling of wall and ceiling paintwork, prepare the surface and apply epoxy paint as per the manufacturers requirements to suit BSL3, or wall and ceiling finish that is functionally equivalent in a BSL3 facility, that is cost effective, durable, chemical resistant and easy to clean.

Replace the existing worktop/bench finish with either epoxy or functionally equivalent finish in a BSL3 bech finish that is cost effective, durable, chemical rsistant and easy to

lintroduce a pass through window at the indicated area in the layout.

Inspect and ensure that the existing aluminium windows are airtight.

Inspect and ensure that the equipment access door and ante room doors are airtight., or can be repaired to be airtight or replaced with airtight doors of similar sizes applicable within BSL3 and ante room.

Introduce applicable storage cabinets and step over bench in the ante room at the areas indicated in the layout.

Other works as per the attached URS.

LEGEND

Floor tiles finish cover area Epoxy floor finish cover area

Bench top finish to be cost effective, durable, chemical resistant and easy to clean

1600mm long x 400mm wide x 400mm high and fully open on one side for shoe storage Stainless steel stepover bench or equivalent

3200mm long x 600mm wide x 2100mm high Stainless steel cupboard for PPES, PCR/ Emergency kits storage



C-BSC - CLEAN BIOSAFETY CABINET D-BSC - DIRTY BIOSAFETY CABINET

B6 - BSC 6ft. B4 - BSC 4ft. HWS - HANDWASH SINK

S - SINK

F - FRIDGE Fr. - FREEZER I - INCUBATOR

C - CENTRIFUGE 960 - MGT960

P - PASS THROUGH INCLUDING SPECIMEN PLACEMENT BASE TO REQUIREMENTS E - EQUIPMENT DOOR

W - VIEWING SEALED WINDOW

SH - SHOWER **EEW-EMERGENCY EYE WASH**

ESH-EMERGENCY SHOWER

DR - DRAWERS

A - AUTOCLAVE

PL - PRINTER LABEL

HB - HIGH BENCH _1050mm high LB - LOW BENCH 900mm high

E.O.T.ELBOW OPERATED TAPS


F A- FREE STANDING AUTOCLAVE

ARCHITECTURAL NOTES.

- 1. All works to be carried out in accordance with Local
- Authority regulations.
 2. All figured dimensions to be taken in preference
- to scaled dimensions.
- 3. All walls below 200mm to be reinforced with hoop
- iron at every alternative course. 4. Provide damp proof course (D.P.C.) under all walls.
- 5. P.V. indicates permanent ventilations. 6. All drainage passing under building and drive area to be of pvc pipe and encased in 150mm
- thick concrete surround. 7. All inspection chambers in drive area to have
- heavy duty covers. 8. Check all dimensions on site.
- 9. All sanitary work to be in accordance with MOH rules
- and regulations and NCC requirements. 500g polythene sheeting and anti-termite treatment
- to be provided under ground floor concrete slab.
- All reinforced concrete works to Structural Eng. detail
- 12. Automatic booster pump for FHRs to be provided to the satisfaction of the Chief Fire Officer.
- 13. 4500 litres reserve for hose reel
- 14. Electrical fire alarm system to the approval of Chief Fire Officer. 15. Fire alarm and booster to be provided with
- secondary power supply.

 16. 2x9 kg Dry Powder Fire Extinguishers at areas shown.
- 17. 2x9 litre water and 1x4.5 kg CO2 fire extinguishers to be provided per floor.

Revision	Date

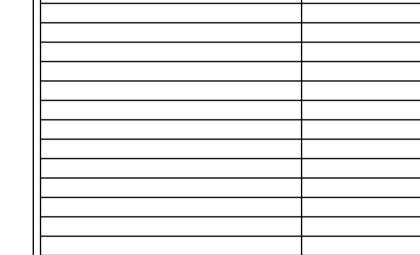



P.O BOX 12814-20100 NAKURU

EMAIL:info@tetradesigns.co.ke

TEL: +254729528772

Architects	signature	

NATIONAL PUBLIC HEALTH LABORATORY, DEPARTMENT OF LABORATORY SERVICES (DLS), MINISTRY OF HEALTH

AMREF HEALTH AFRICA IN KENYA **WILSON AIRPORT,**

P.O. BOX 20750-00202,

Client sign

Project Title PROPOSED RENOVATION AND MAINTENANCE OF BSL III LABORATORIES AT NATIONAL PUBLIC HEALTH LABORATORY (BLOCK B) AT THE DEPARTMENT OF

KENYATTA NATIONAL HOSPITAL GROUNDS -OFF NGONG ROAD

Project No.TD/NKU/22/04/125

Drawing Title

FOURTH FLOOR

FOURTH FLOOR PLINTH AREA:

Drawing Status

WORKING DRAWINGS

Drawn by Renovations/Design by Checked by

Arch. Boaz. Kim JAN,2025

Scales

1:100

Status

Drawing Number Revision

GRILLS BARRIER AND ACCESS CONTROL GATE

GRILLS BARRIER AND GATE TO BE DONE AT THE BACK

BLOCK B

AREA TO BE PAVED

EXISTING MASONRY


INCINERATOR

EXTERNAL WORKS (SITE PLAN)

SCALE 1:100

BE EXTENDED

GRILLS AND SLIDING GATE

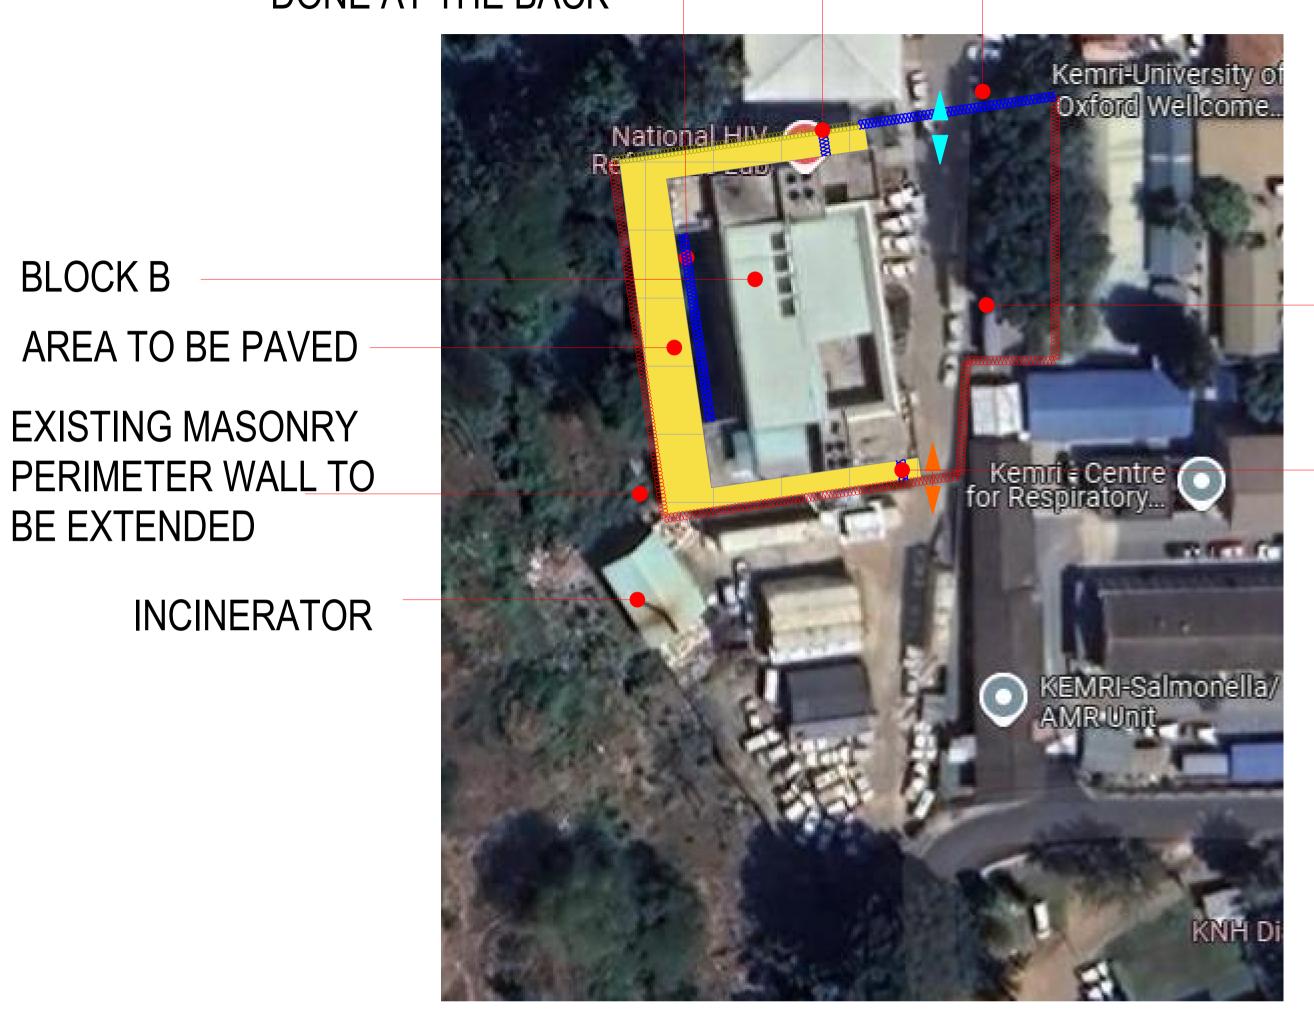

NEW GENERATOR HOUSE POSITION


GRILLS BARRIER AND GATE TO BE DONE AT THE BACK

SUMMARY OF OTHER EXTERNAL RENOVATION WORKS


Masonry boundary wall construcion/extension, Grills and access controlled gates construction as described in the attached USR, including electric fence and razor wire.

Installing paving blocks at the back and sides of the building. Installation of a new generator house at the specified position.

LEGEND

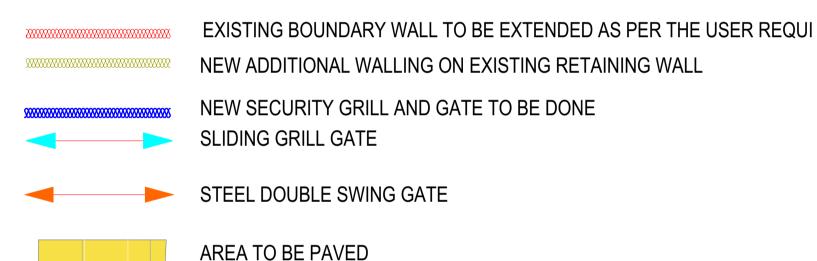


GENERATOR HOUSE PROPOSAL

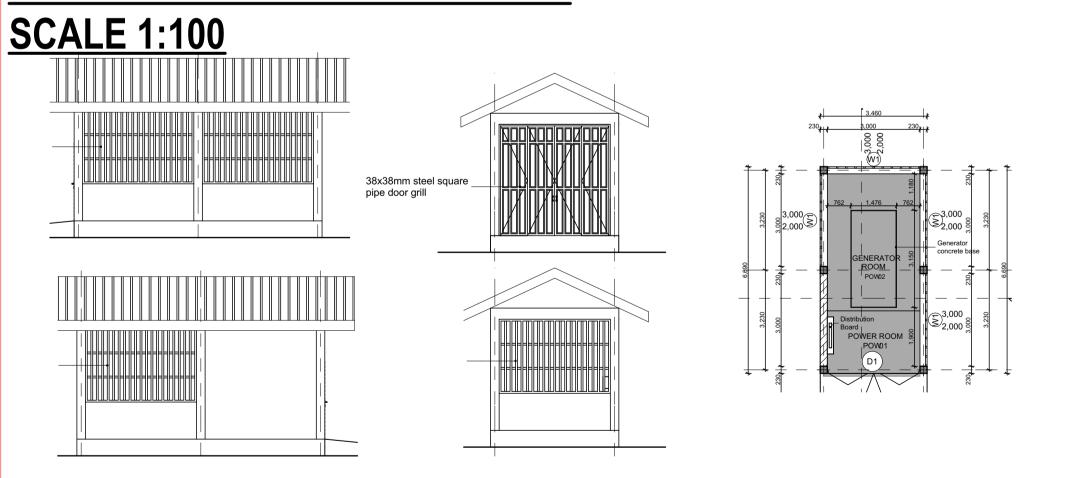


metal grills at 150mm centres


Electric fence and razor wire TOTAL LENGTH: GATE SIZE AND DESIGN: Masonry wall-COLUMN SPECs Ground level FOUNDATION SPECS OTHER: PART OF ELEVATION SCALE: NTS Masonry wall with electric fence and razor wire

To be determined upon site measurement as per the marked areas Double swing Grill steel gate of width 4800mm, 300 x 200 mm columns at 3,000mm centre to centre Details to be determined upon site visit, analysis of soil conditions— As per the attcahed specifications

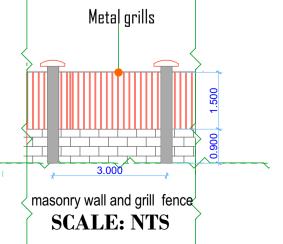

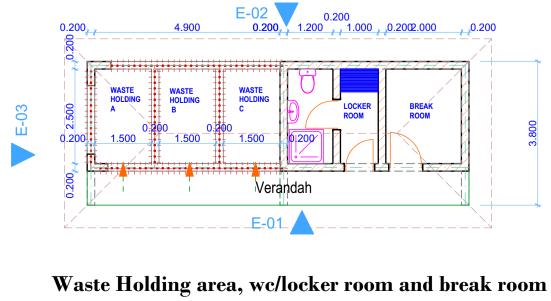

SCALE: NTS

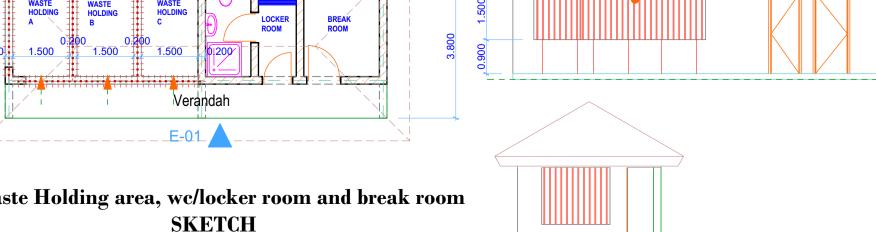

5. P.V. indicates permanent ventilations. 6. All drainage passing under building and drive area to be of pvc pipe and encased in 150mm thick concrete surround. 7. All inspection chambers in drive area to have heavy duty covers. 8. Check all dimensions on site. 9. All sanitary work to be in accordance with MOH rules and regulations and NCC requirements. 10. 500g polythene sheeting and anti-termite treatment to be provided under ground floor concrete slab. 11. All reinforced concrete works to Structural Eng. detail 12. Automatic booster pump for FHRs to be provided to the satisfaction of the Chief Fire Officer. 13. 4500 litres reserve for hose reel 14. Electrical fire alarm system to the approval of Chief Fire Officer. 15. Fire alarm and booster to be provided with secondary power supply.

16. 2x9 kg Dry Powder Fire Extinguishers at areas shown. 17. 2x9 litre water and 1x4.5 kg CO2 fire extinguishers to be provided per floor. LETRA DESIGNS LIMITED P.O BOX 12814-20100 NAKURU TEL: +254729528772 EMAIL:info@tetradesigns.co.ke Architects signature. NATIONAL PUBLIC HEALTH LABORATORY, DEPARTMENT OF LABORATORY SERVICES (DLS), MINISTRY OF HEALTH P.O. BOX 20750-00202, AMREF HEALTH AFRICA IN KENYA **WILSON AIRPORT,** Client sign Project Title PROPOSED RENOVATION AND MAINTENANCE OF BSL III LABORATORIES AT NATIONAL PUBLIC HEALTH LABORATORY (BLOCK B) AT THE DEPARTMENT OF KENYATTA NATIONAL HOSPITAL GROUNDS -OFF NGONG ROAD Project No.TD/NKU/22/04/125 Drawing Title EXTERNAL WORKS (SITE PLAN) FOURTH FLOOR PLINTH AREA: Drawing Status WORKING DRAWINGS Drawn by Renovations/Design by Checked by Arch. Boaz. Kim JAN,2025 Scales 1:100 **Drawing Number** Status Revision

ARCHITECTURAL NOTES

Authority regulations.

to scaled dimensions.

iron at every alternative course.

1. All works to be carried out in accordance with Local

2. All figured dimensions to be taken in preference

3. All walls below 200mm to be reinforced with hoo

4. Provide damp proof course (D.P.C.) under all walls